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MINOR SITE PLAN FOR OCALA SUNTRAN RESTROOMS AND KIOSK CITY OF OCALA, FLORIDA

PARCEL ID: 28235-001-00

APRIL 2024

GENERAL NOTES:

- ALL CONSTRUCTION COVERED BY THESE PLANS SHALL COMPLY WITH THE MATERIAL REQUIREMENTS AND QUALITY CONTROL STANDARDS CONTAINED IN THE CITY OF OCALA LAND DEVELOPMENT CODE AS APPLICABLE.
- NO CHANGE TO THE WORK AS SHOWN ON THE APPROVED PLANS SHALL BE MADE WITHOUT NOTIFICATION TO AND APPROVAL OF BOTH THE CITY ENGINEER AND PROJECT ENGINEER.
- THE CONTRACTOR SHALL VERIFY THE LOCATION AND COVER OF ALL EXISTING UTILITIES AND REPORT ANY DISCREPANCY TO THE PROJECT ENGINEER. THERE MAY BE ADDITIONAL UTILITIES NOT SHOWN ON THESE PLANS. CAUTION IS ADVISED PRIOR TO DIGGING. IT IS IMPORTANT THAT "UTILITY LOCATES" BE PERFORMED ON-SITE.
- TYPE III SILT FENCE SHALL BE INSTALLED AS SHOWN ON THESE PLANS PRIOR TO ANY CONSTRUCTION, MAINTAINED DURING THE LIFE OF THE PROJECT, AND REMOVED FOLLOWING COMPLETION OF CONSTRUCTION.
- THE SITE SHALL REMAIN FREE OF EXCESS DUST AND DEBRIS AT ALL TIMES. ANY INCIDENCE OF EROSION, SEDIMENTATION, DUST OR DEBRIS OCCURRING OFF-SITE AS A RESULT OF CONSTRUCTION ACTIVITIES ON THIS DEVELOPMENT SHALL BE CORRECTED BY THE CONTRACTOR WITHIN 48 HOURS OF EACH OCCURRENCE.
- ALL DRAINAGE FACILITIES AND STORM STRUCTURES MUST BE BUILT PRIOR TO CONSTRUCTION OF ANY IMPERVIOUS SURFACES.
- ASPHALT PAVEMENT ON-SITE SHALL BE 1-1/2" THICK (F.D.O.T. TYPE SP-9.5) ON 8" LIMEROCK BASE (98% MAX DENSITY, 100 LBR), ON 12" STABILIZED SUBGRADE (98% MAX DENSITY, 40 LBR). CONSTRUCTION REQUIREMENTS OF THE FDOT STANDARD SPECIFICATIONS FOR ROAD AND BRIDGE CONSTRUCTION (LATEST EDITION) SHALL GOVERN.
- IF UNSUITABLE MATERIAL IS ENCOUNTERED WITHIN PARKING AREA, TWO (2) FEET OF UNDERCUT BELOW THE PROPOSED LIMEROCK BASE TOGETHER WITH SUITABLE BACKFILL MATERIAL IS REQUIRED. THE CONTRACTOR SHOULD PROVIDE A UNIT PRICE IN HIS INITIAL BID, AND HE SHALL NOTIFY THE PROJECT ENGINEER WHEN UNSUITABLE MATERIAL IS ENCOUNTERED, BEFORE PROCEEDING WITH ANY WORK RELATED TO UNSUITABLE MATERIAL. THE CONTRACTOR IS ADVISED TO CONTACT A LICENSED GEOTECHNICAL ENGINEER TO DETERMINE THE SUITABILITY OF THE INSITU SOIL AND THE AREA OF UNDERCUT THAT IS REASONABLY REQUIRED.
- ALL SIGN POSTS TO BE U-CHANNEL GALVANIZED STEEL 2lbs/L.F. BREAKAWAY POSTS.
- ANY DISTURBED AREAS LEFT UNPAVED SHALL BE FINISH GRADED AND SODDED WITH ARGENTINE BAHIA. CONTRACTOR MUST FINISH GRADE AT 2" UNDERCUT OF PROPOSED GRADES TO ALLOW FOR THICKNESS OF SOD.
- IF A SINKHOLE SHOULD FORM ON THIS SITE, ALL APPLICABLE REPAIR PROCEDURES SHALL BE FOLLOWED AS OUTLINED IN TYPICAL SINK CHIMNEY REPAIR DETAIL SHOWN HEREON. ALSO, THE CITY OF OCALA AND SJRWMD SHALL BE NOTIFIED IMMEDIATELY.
- KIMLEY-HORN, INC. AND ITS EMPLOYEES ARE NOT RESPONSIBLE FOR ON-SITE SAFETY DURING CONSTRUCTION.
- THERE ARE NO WETLANDS ON THIS SITE.
- THE SITE CONTRACTOR SHALL INCLUDE THE PROVISION OF A COMPREHENSIVE AS-BUILT SURVEY FOR THE ENTIRE PROJECT IN HIS CONTRACT. THIS SURVEY MUST BE PERFORMED BY A FLORIDA REGISTERED LAND SURVEYOR (FIELD AND OFFICE WORK) AND PROVIDED TO THE PROJECT ENGINEER IN BOTH PDF AND ACAD FORMATS PRIOR TO G.O. THE AS-BUILT SURVEY SHALL INCLUDE VALVE TIE SHEETS FOR ANY NEW VALVES, TOGETHER WITH THE TYPE, SIZE, LOCATION, DEPTH, SLOPE (WHERE APPLICABLE), ETC. OF ALL UTILITIES. IMPORTANT!! THE LOCATIONS AND TOP OF PIPE ELEVATIONS FOR ALL VERTICAL & HORIZONTAL BENDS, TEES, VALVES, AND WYES MUST BE PROVIDED ON THE AS-BUILTS. THE PROJECT ENGINEER WILL REVIEW THE INFORMATION FOR CERTIFICATION BEFORE FINAL PAYMENT WILL BE APPROVED. AN INCOMPLETE AND/OR INACCURATE AS-BUILT SURVEY WILL BE REJECTED, AND THE ENGINEER WILL NOT BE RESPONSIBLE FOR ANY DELAY IN OBTAINING THE C.O.
- THE GEOTECHNICAL TESTING COMPANY SHALL BE HIRED BY THE OWNER AND THE SPECIFICATIONS FOR THE TESTING SHALL BE GIVEN BY THE PROJECT ENGINEER. ALL TESTS SHALL BE PAID FOR BY THE CONTRACTOR.

UTILITY PROVIDERS:

ELECTRIC:
CITY OF OCALA ELECTRIC UTILITY
1805 NE 30TH AVE., BLDG 400
OCALA, FL 34470
RANDY HAHN
(352) 351-6615

FIBER & TELEPHONE:
LUMEN (LOCAL)
501 MCCORMACK ST
LEESBURG, FL 34748
JOHN PLAMONDON
(352) 425-4444

FIBER:
CITY OF OCALA FIBER
1805 NE 30TH AVE., BLDG. 500
OCALA, FL 34470
OSHANE PARKER
(352) 401-6950

FIBER & TELEPHONE:
LUMEN (NATIONAL)
7003 PRESIDENTS DR, STE. 100
ORLANDO, FL 32809
MICHAEL HUNT
716-480-2076

WATER & SEWER:
CITY OF OCALA, WATER & SEWER
2100 NE 30TH AVE.
OCALA, FL 34470
STACEY FERRANTE
(352) 351-6775

COMMUNICATION LINES & FIBER:
VERIZON
400 S. LAKE DESTINY
ORLANDO, FL 32810
TIM COLE
(407)-618-2078

GAS:
TECO PEOPLES GAS-OCALA
316 SW 33RD AVE.
OCALA, FL 34474
LONDON MEAHL
(407) 408-5566

GENERAL STATEMENT:

THE CHARACTER AND INTENDED USE OF THIS DEVELOPMENT SHALL BE TO CONSTRUCT 460 SF TICKET KIOSK AND RESTROOMS BUILDING.

AGENCY PERMITS:

CITY OF OCALA ONGOING
SJRWMD ONGOING

STANDARD NOTES:

- REPRODUCTION OF THESE PLANS IS NOT VALID UNLESS SIGNED BY THE ENGINEER IN RESPONSIBLE CHARGE AND SEALED WITH RAISED EMBOSSED SEAL.
- COPIES OF THESE PLANS AS DESIGNED BY THE PROFESSIONAL ENGINEER HAVE BEEN RETAINED BY THE ENGINEER AND HE WILL NOT BE HELD RESPONSIBLE FOR ANY SUBSEQUENT UNAUTHORIZED CHANGES TO THE REPRODUCIBLE ORIGINAL DOCUMENTS.

DRAWING INDEX

C01 - COVER SHEET
C01.1 - MASTER LAYOUT
C02 - DEMOLITION PLAN
C03 - LAYOUT AND GRADING PLAN
C04 - STORMWATER POLLUTION PREVENTION PLAN
C05 - CONSTRUCTION DETAILS

SITE DATA:

PROJECT NAME OCALA SUNTRAN RESTROOMS AND KIOSK
PROJECT LOCATION NE 5TH ST @ NE 1ST AVE
OCALA, FL 34785
OWNER CITY OF OCALA
1805 NE 30TH AVE. BLDG 700
OCALA, FL 34470-4882
ZONING GU
FUTURE LAND USE HIGH INTENSITY/CENTRAL CORE
PARCEL ACCT. NO. 28235-001-00
PROJECT AREA 126,716 S.F. = 2.91 ACRES
IMPERVIOUS AREA NO CHANGE FROM PRE-DEVELOPMENT
FLOOD ZONE X
NEW BUILDING SIZE 460 S.F.
NEW BUILDING HEIGHT 15 FEET
NEW BUILDING NUMBER OF STORIES 1 STORY

SURVEY:

CONTACT: ECHEZABAL AND ASSOCIATES, INC.

NOTE: SEE TOPOGRAPHIC SURVEY BY ECHEZABAL AND ASSOCIATES FOR BEARINGS & DISTANCES, MONUMENTATION, SECTION DATA, DATUM, FENCES, NOTES, AND SURVEYOR'S CERTIFICATION.

PRE-CONSTRUCTION MEETING:

NO SITE WORK SHALL BE CONDUCTED PRIOR TO OBTAINING A SITE PERMIT FROM THE CITY OF OCALA. CALL THE CITY GROWTH MANAGEMENT DEPARTMENT AT 352-692-8421 TO SCHEDULE A PRE-CONSTRUCTION MEETING.

ENGINEER'S CERTIFICATION:

I HEREBY CERTIFY THAT THESE PLANS AND CALCULATIONS WERE COMPLETED IN ACCORDANCE WITH ALL APPLICABLE REQUIREMENTS OF THE CITY OF OCALA LAND DEVELOPMENT CODE EXCEPT AS WAIVED, THAT THE ADJACENT PROPERTIES WILL BE PROTECTED FROM STORMWATER DAMAGE AS A RESULT OF THIS PROPOSED DEVELOPMENT, THAT THE DRAINAGE FACILITIES INCORPORATED HEREON ARE SUFFICIENT IN SIZE, AND THAT SIGHT DISTANCE AT DRIVEWAYS COMPLY WITH A.A.S.H.T.O. AND THE F.D.O.T. SITE IMPACT HANDBOOK. I FURTHER CERTIFY THAT THIS PLAN MEETS ALL REQUIREMENTS OF THE F.D.E.P. AND S.J.R.W.M.D.

OF KIMLEY-HORN AND ASSOCIATES, INC.

DATE:



Kimley»Horn

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1700 SE 17TH STREET, SUITE 200, OCALA, FLORIDA 34471
PHONE: 352-438-3000
WWW.KIMLEY-HORN.COM REGISTRY NO. 35108

LICENSED PROFESSIONAL
MOHAMMED N. MURAD, P.E.
FLORIDA LICENSE NUMBER
91243

KHA PROJECT
142371043
DATE
APRIL 2024
SCALE AS SHOWN
DESIGNED BY KHA
DRAWN BY TEF
CHECKED BY MAM

COVER SHEET

SUNTRAN RESTROOMS
AND KIOSK
PREPARED FOR
CITY OF OCALA
FLORIDA
CITY OF OCALA

SHEET NUMBER
C01

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No.	REVISIONS	DATE	BY

SUNTRAN RESTROOMS
AND KIOSK
PREPARED FOR
CITY OF OCALA

CITY OF OCALA
FLORIDA

SHEET NUMBER
C01.1

MASTER LAYOUT

KHA PROJECT
142371043

DATE
APRIL 2024

SCALE AS SHOWN

DESIGNED BY KHA

DRAWN BY TEF

CHECKED BY

LICENSED PROFESSIONAL

MOHAMMED N. MURAD, P.E.

FLORIDA LICENSE NUMBER
91243

DATE: _____

MNM

REVIEWED



for Code Compliance
City of Ocala Growth Management

SPLA614-45685-Suntran Union
Bryan Matheson - Kiosk
5/20/24

Kimley»Horn

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WWW.KIMLEY-HORN.COM REGISTRY NO. 35106

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

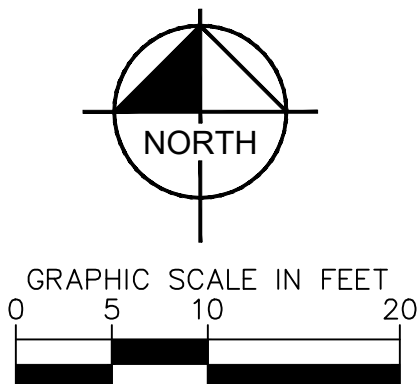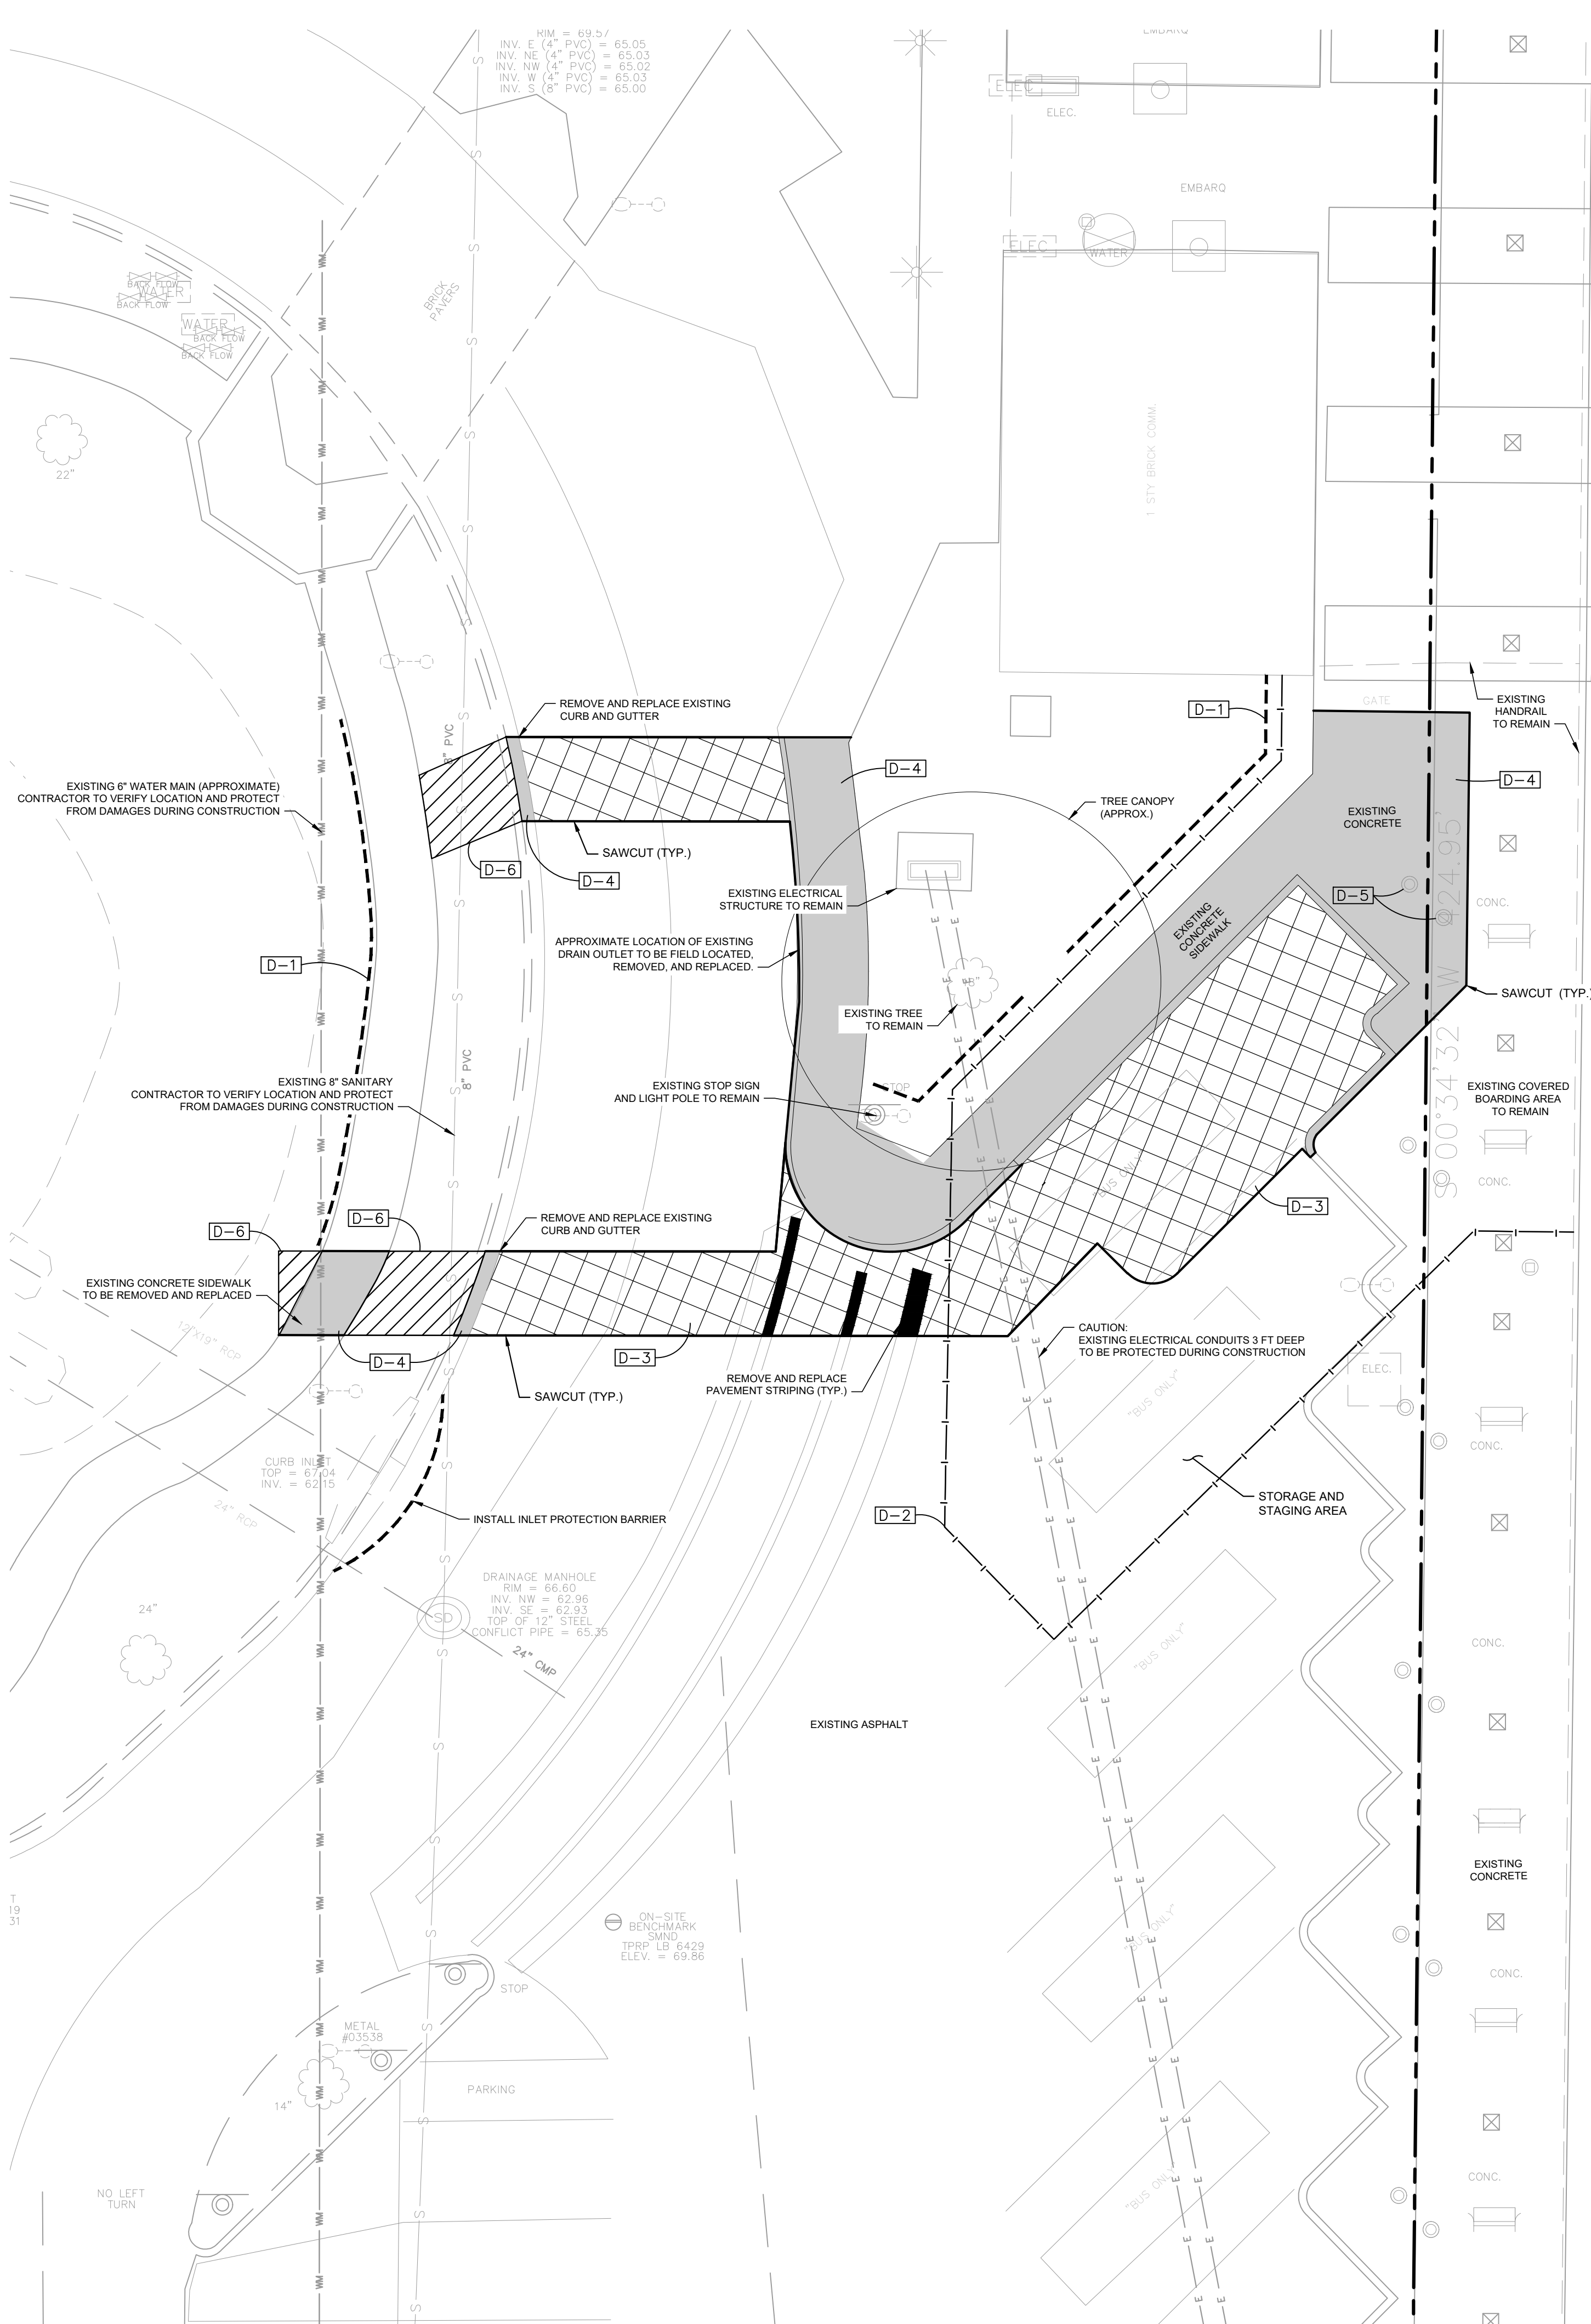
TREE PRESERVATION NOTE:
TREE PRESERVATION MEASURES MUST BE INSTALLED AND INSPECTED PRIOR TO ANY DEMOLITION ACTIVITIES.


GENERAL DEMOLITION NOTES:

2. ALL MATERIAL REMOVED FROM THIS SITE BY THE CONTRACTOR SHALL BE DISPOSED OF BY THE CONTRACTOR IN A LEGAL MANNER.
3. REFER TO THE TOPOGRAPHIC SURVEY FOR ADDITIONAL DETAILS OF EXISTING STRUCTURES, ETC., LOCATED WITHIN THE PROJECT SITE. UNLESS OTHERWISE NOTED, ALL EXISTING BUILDINGS, STRUCTURES, SLABS, CONCRETE, ASPHALT, DEBRIS PILLS, SIGNS, AND ALL APPURTENANCES ARE TO BE REMOVED FROM THE SITE BY THE CONTRACTOR AND PROPERLY DISPOSED OF IN A LEGAL MANNER AS PART OF THIS CONTRACT. SOME ITEMS TO BE REMOVED MAY NOT BE DEPICTED ON THE TOPOGRAPHIC SURVEY. IF ANY SUCH ITEMS ARE IN QUESTION, THE CONTRACTOR SHALL CONTACT THE OWNER PRIOR TO REMOVAL OF SAID ITEMS.
4. THE CONTRACTOR SHALL REFER TO THE DEMOLITION PLAN FOR DEMOLITION AND/OR PRESERVATION OF EXISTING TREES AND NATURAL AREAS. ALL TREES NOT SPECIFICALLY SHOWN TO BE PRESERVED OR RELOCATED SHALL BE REMOVED AS PART OF THIS CONTRACT IF THEY CONFLICT WITH THE CONSTRUCTION OF ANY OF THE PROPOSED IMPROVEMENTS. TREE PROTECTION SHALL BE PROVIDED AND MAINTAINED THROUGHOUT THE PROJECT PERIOD IN ACCORDANCE WITH THE LOCAL JURISDICTIONAL REQUIREMENTS PRIOR TO ANY DEMOLITION ACTIVITIES TAKING PLACE.

DEMOLITION KEYNOTE LEGEND:

ALL NOTES LISTED BELOW SHALL BE PERFORMED BY THE SITE CONTRACTOR, UNLESS STATED OTHERWISE.

- D-1 INSTALL SILT FENCE. SEE DETAIL ON SHEET C04.
- D-2 INSTALL EITHER 2"x4" WOODEN FENCE OR ORANGE CONSTRUCTION BARRIER FENCE AS SHOWN. SEE DETAILS ON SHEET C05.
- D-3 REMOVE EXISTING ASPHALT PAVEMENT WHERE SHOWN CROSS-HATCHED. 
- D-4 REMOVE EXISTING CURB AND CONCRETE WHERE SHOWN SHADED. 
- D-5 REMOVE EXISTING BOLLARDS.
- D-6 REMOVE AND REPLACE ALL GRASSED AREA THAT IS DISTURBED DURING CONSTRUCTION. 

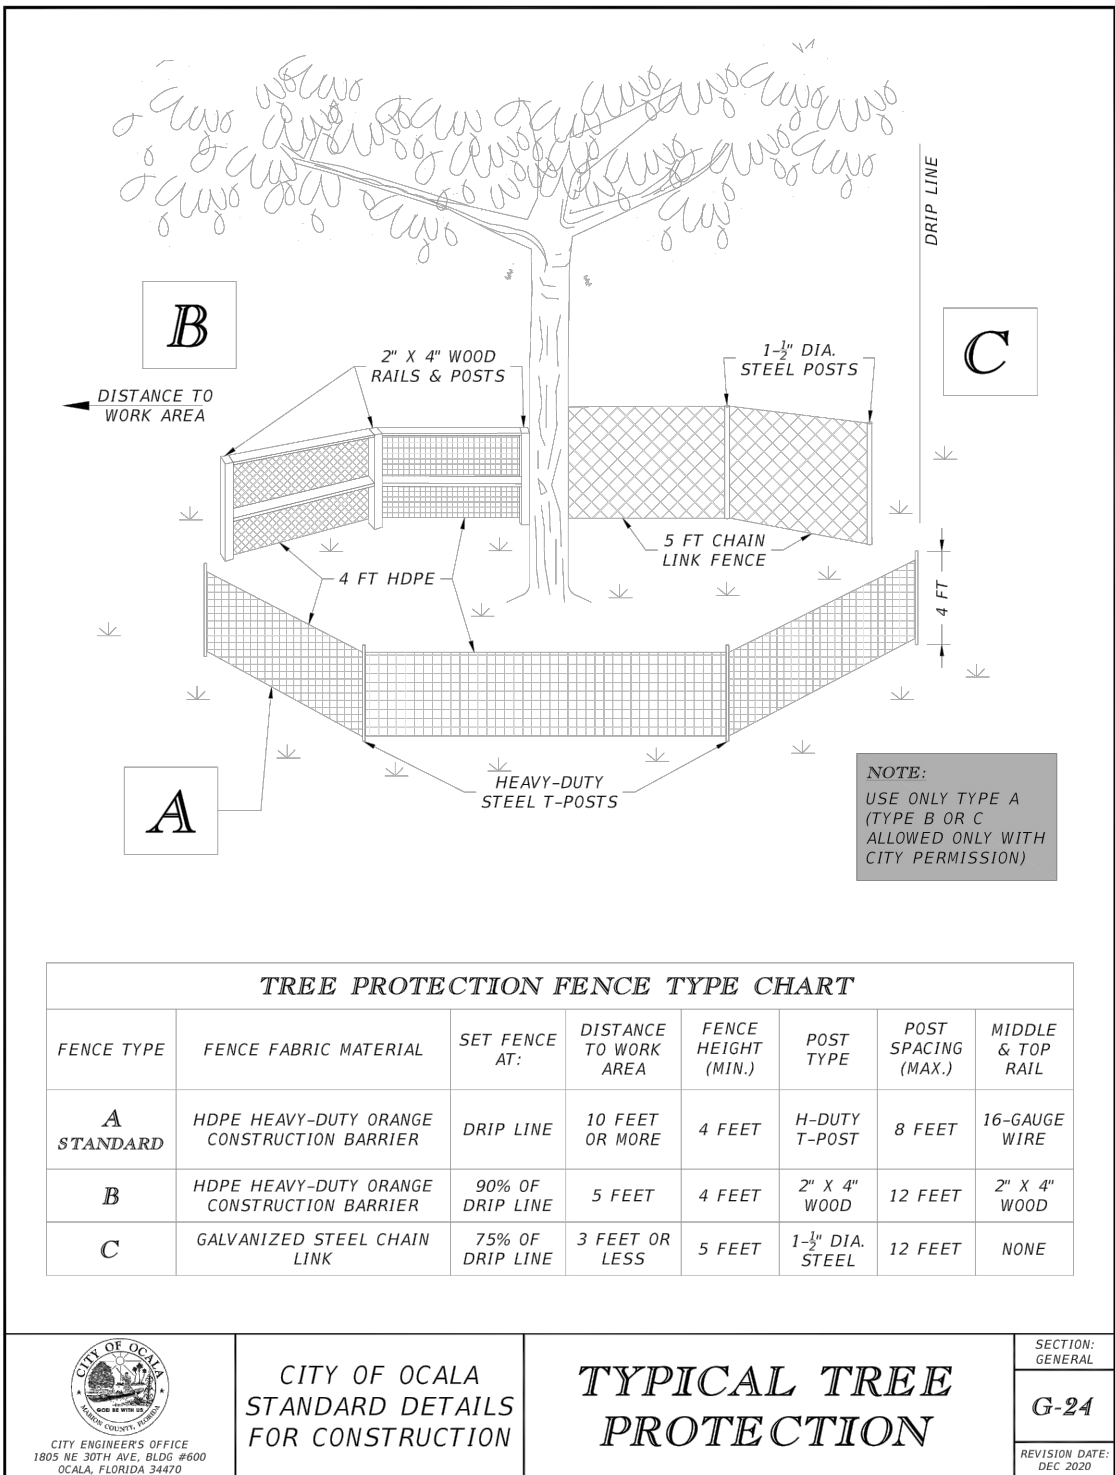[illegible]

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LICENSED PROFESSIONAL

OHAMMED N. MURAD, P.E.

FLORIDA LICENSE NUMBER
Q1243

CHECKED BY	MNM	DATE:
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KHA PROJECT
142371043

DATE _____

APRIL 2024

SIGNED BY	KHA
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ECKED BY MNM


DEMOLITION PLAN

SUNTRAN RESTROOMS
AND KIOSK
PREPARED FOR
CITY OF OCALA






CITY OF OCALA
FLORIDA

SHEET NUMBER
C02

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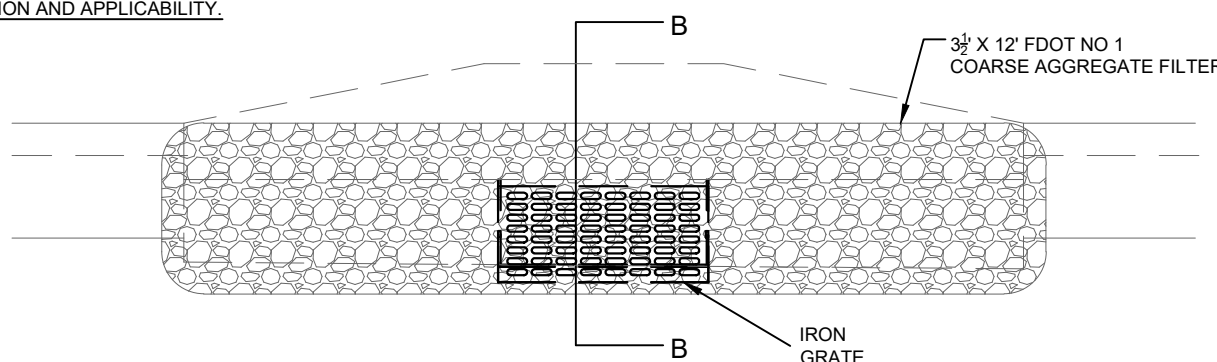

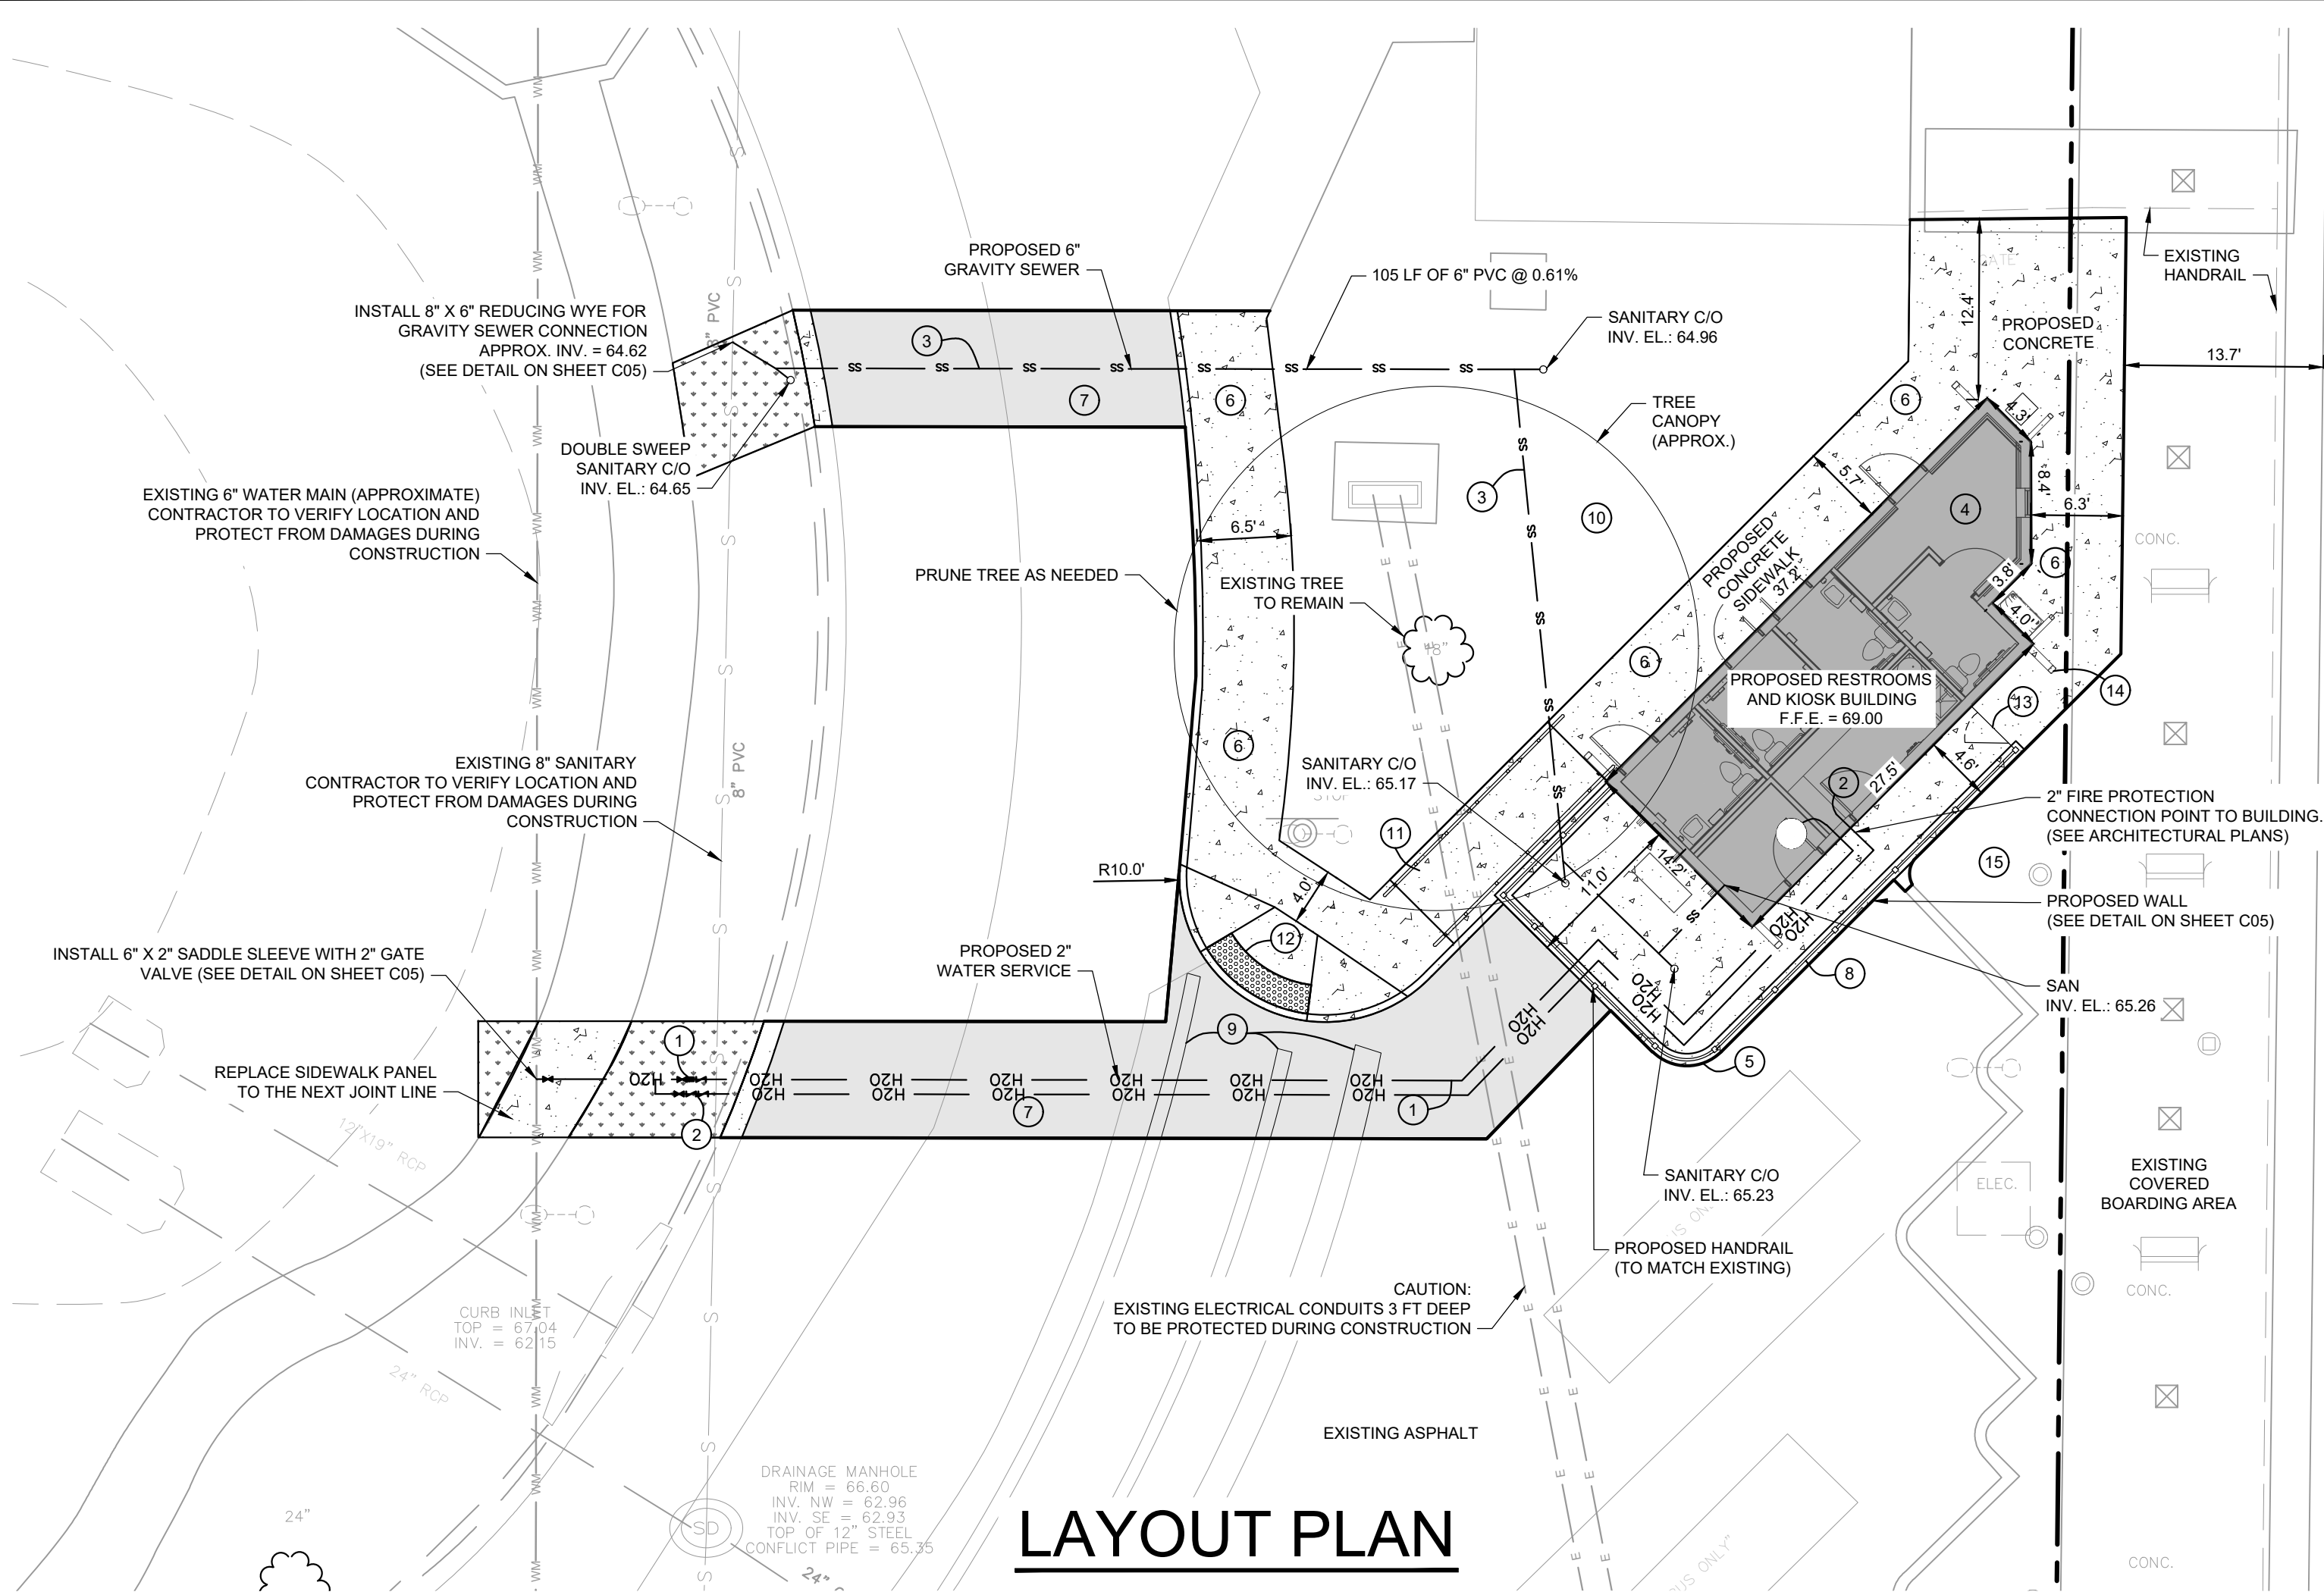
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NOTES:

1. DIMENSIONS OF SEDIMENT FILTER DETAILS MAY BE ADJUSTED FOR TYPE "9" CURB INLET TOPS.
2. PRE-MANUFACTURED INLET SOCK MAY BE SUBSTITUTED IF APPROVED BY THE ENGINEER
3. SEE EROSION CONTROL PLAN FOR LOCATION AND APPLICABILITY.

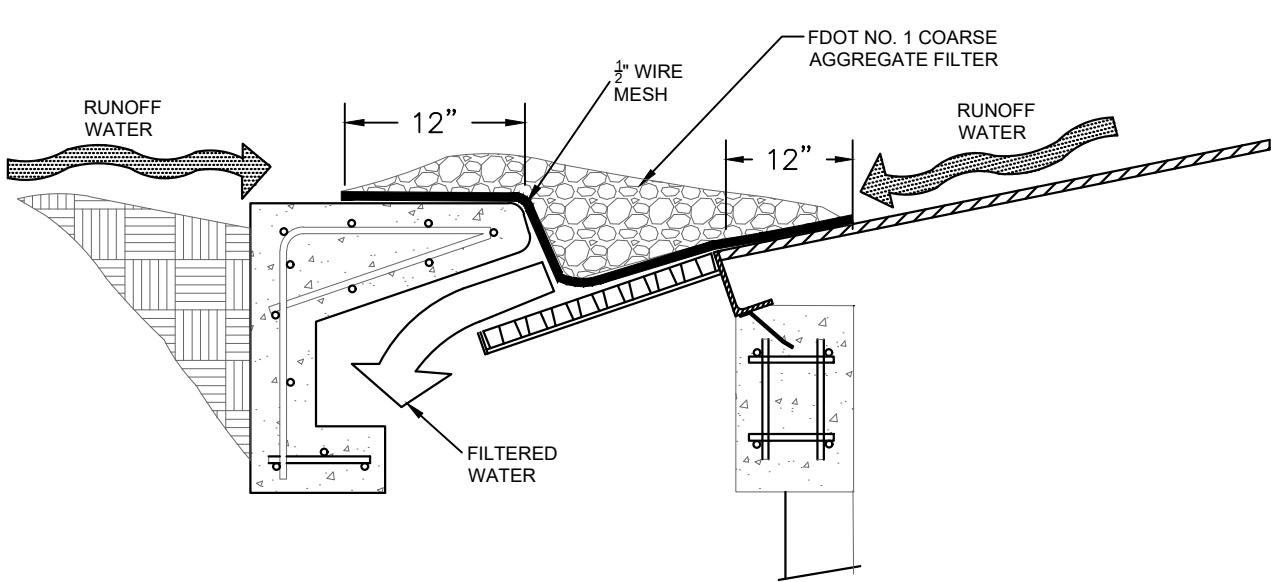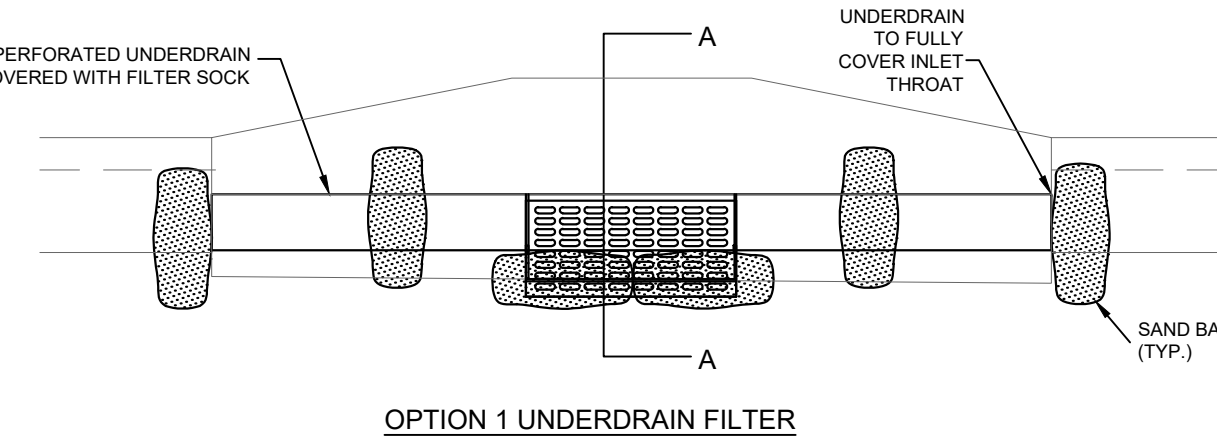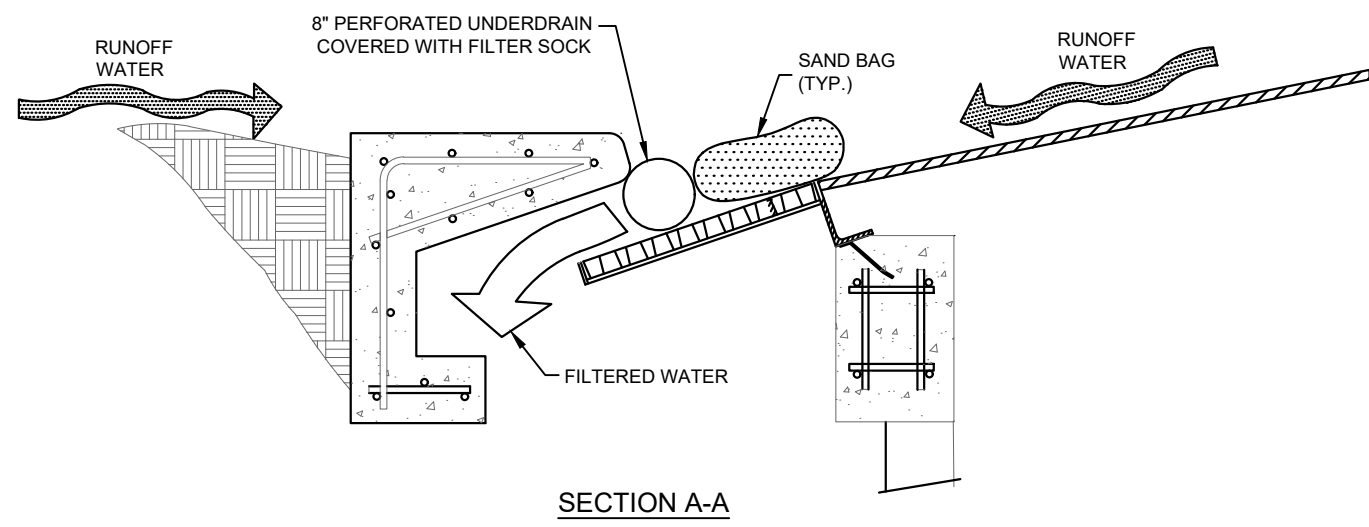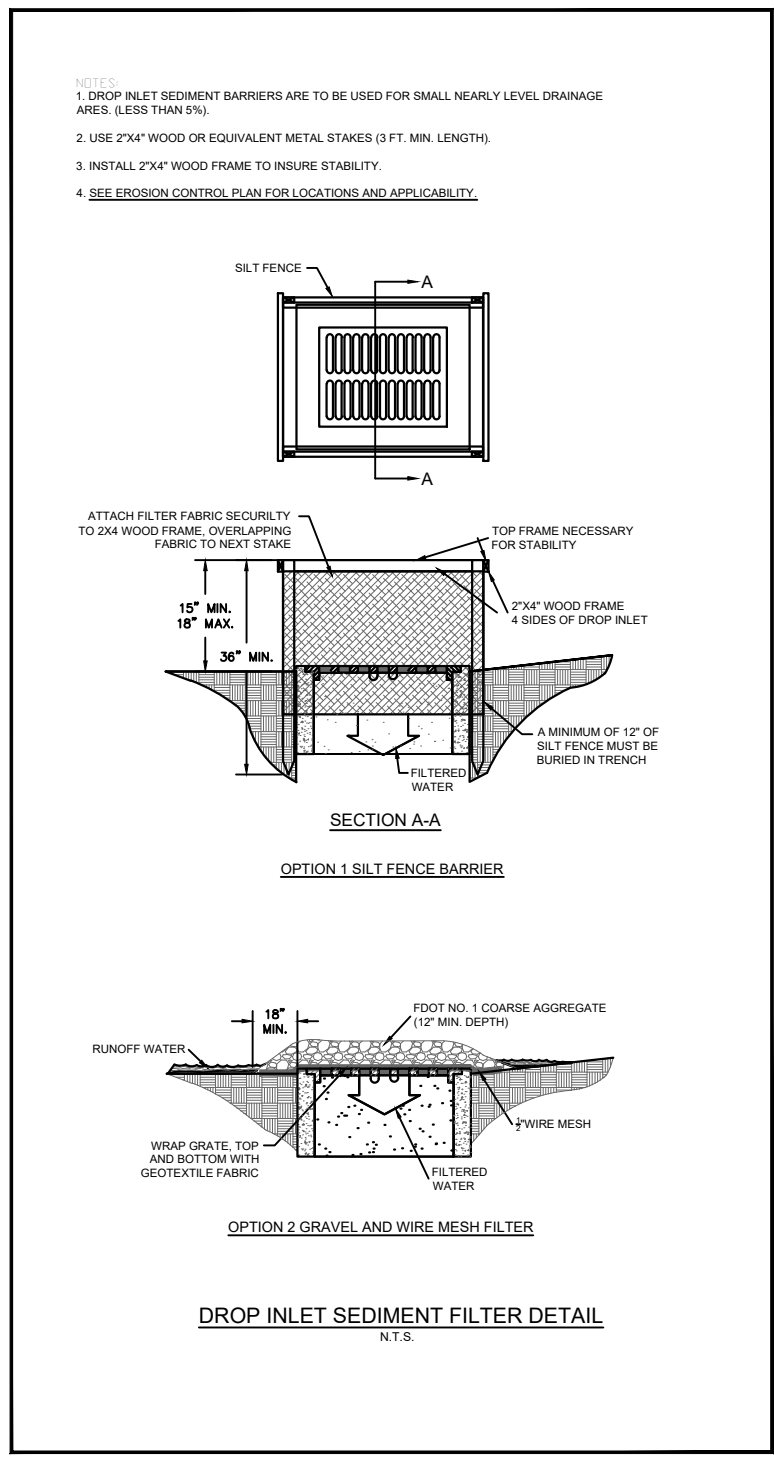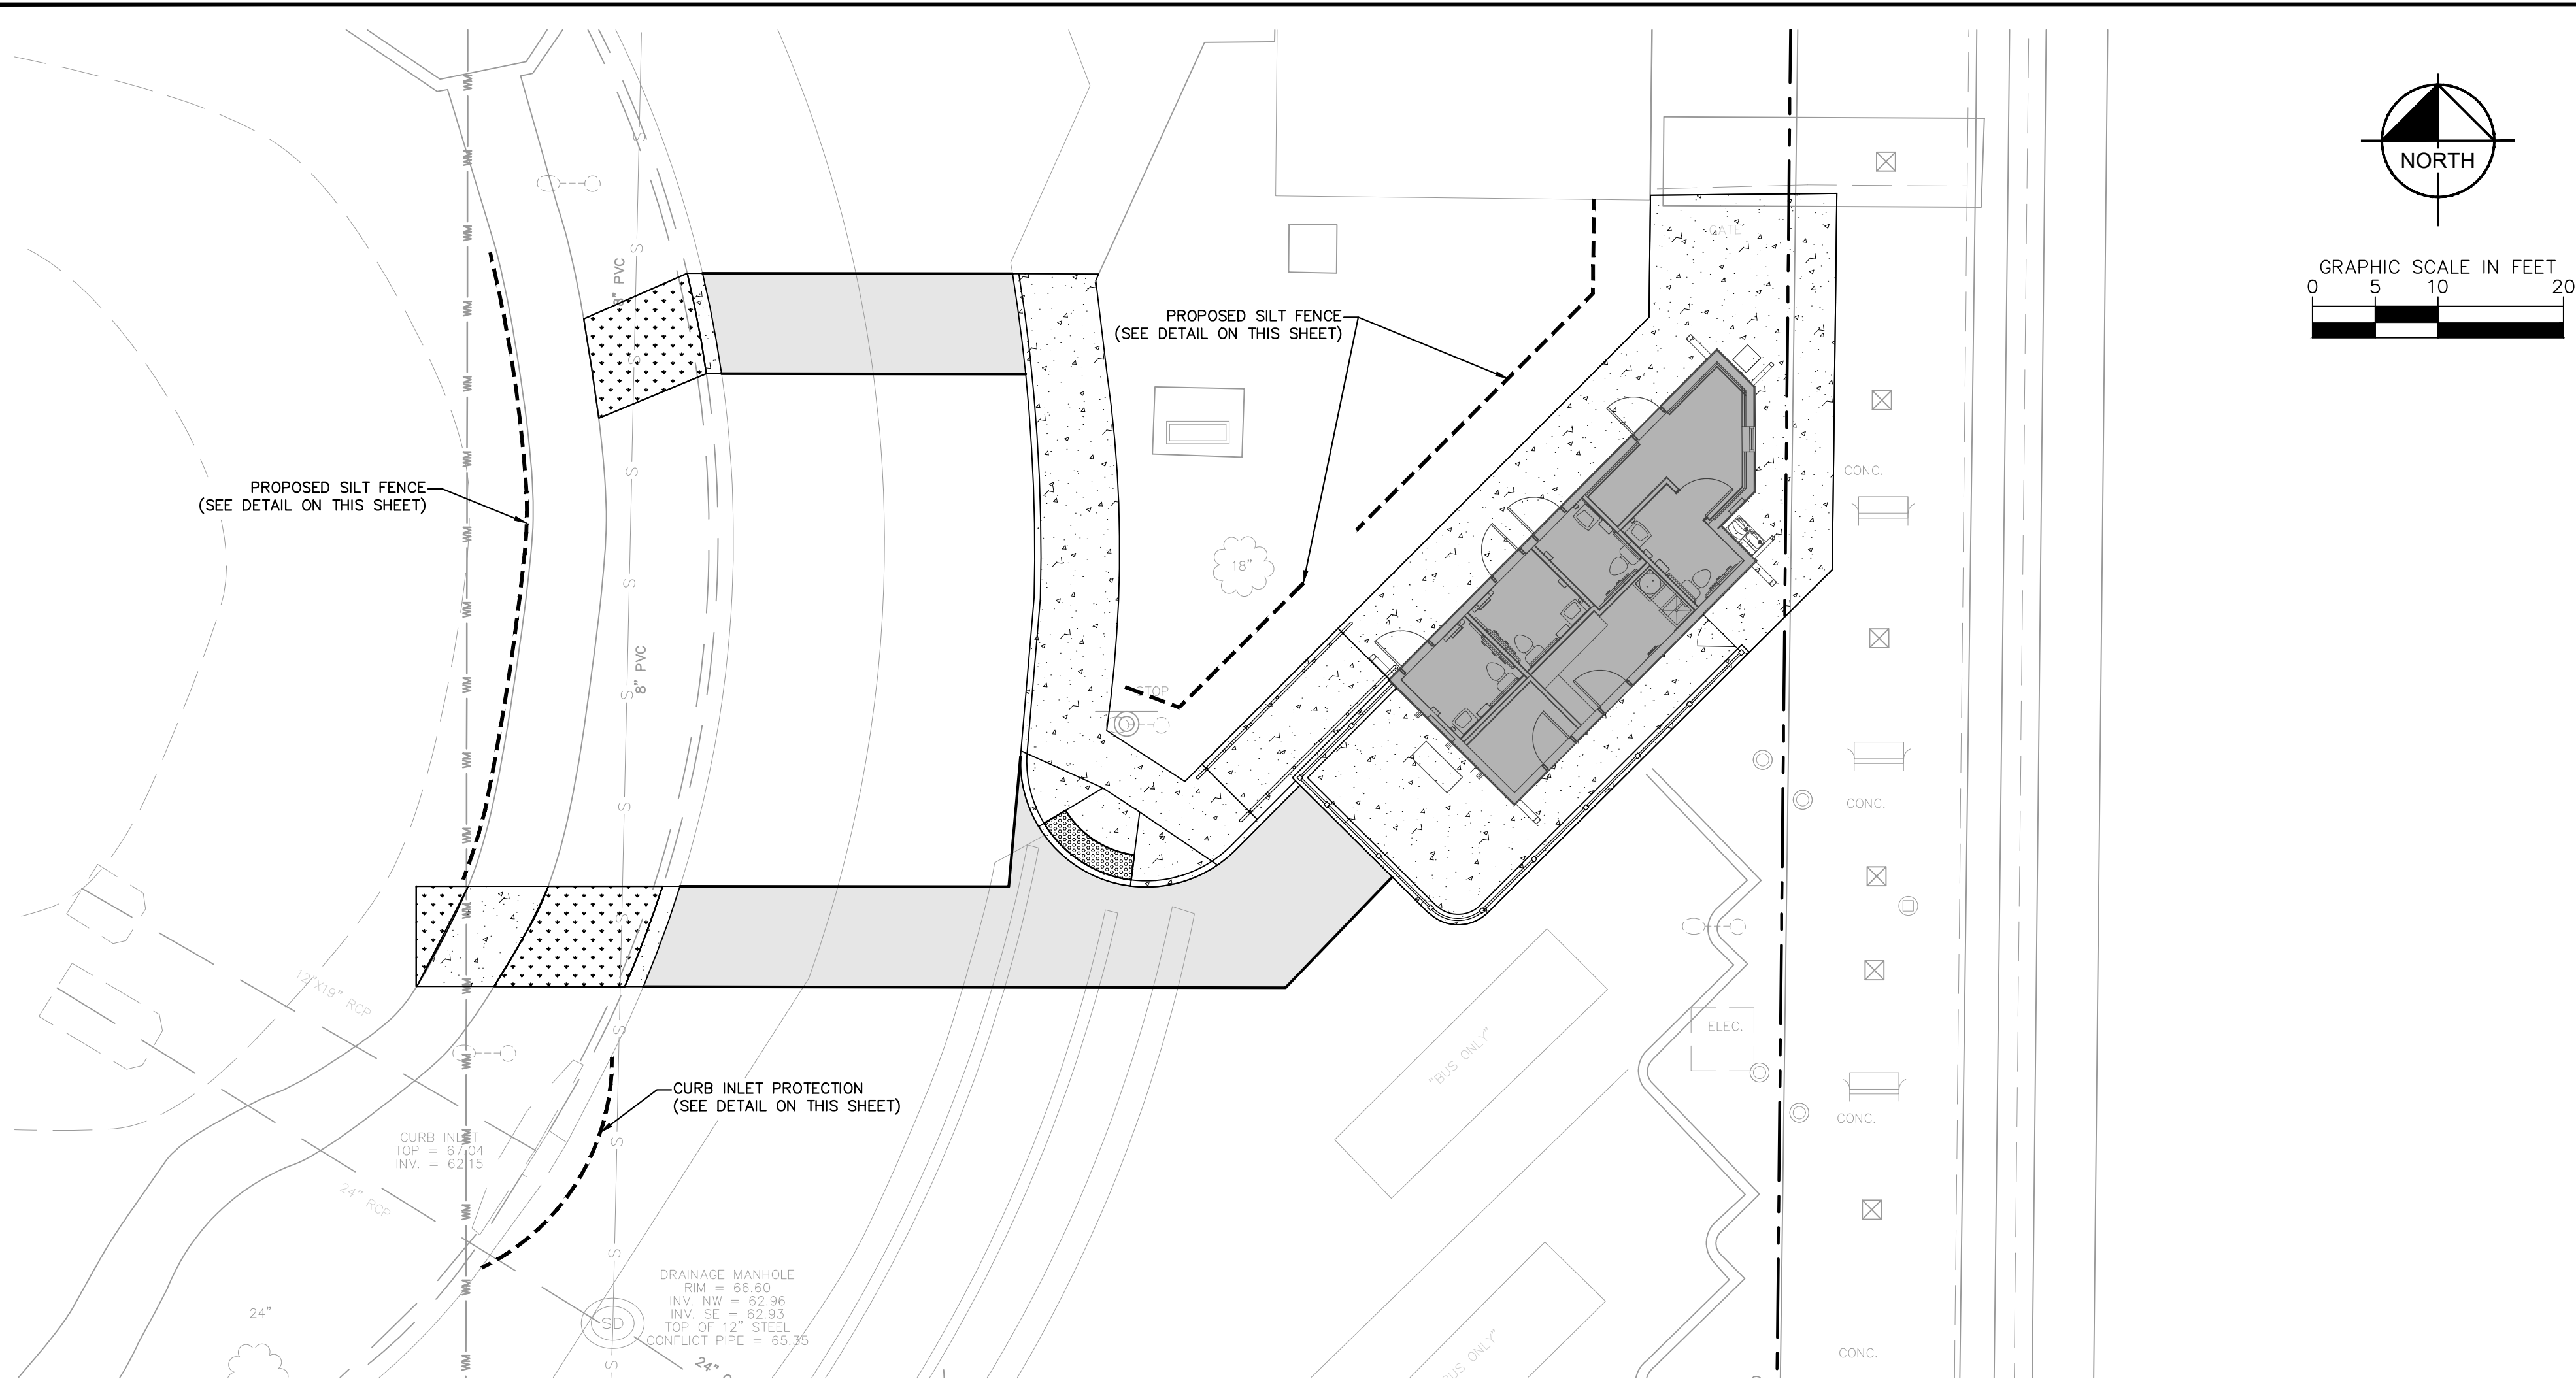


OPTION 2 GRAVEL AND WIRE MESH
CURB INLET SEDIMENT FILTER DETAIL
N.T.S.

- STORMWATER POLLUTION PREVENTION PLAN (S.W.P.P.P.) NOTES:

1. DISCHARGE CONTROL AND EROSION PROTECTION MEASURES SHALL BE EMPLOYED AND OPERATED AT ALL TIMES DURING CONSTRUCTION TO AVOID ADVERSE IMPACTS TO RECEIVING WATERS OR ADJACENT PROPERTY. DETENTION RETENTION STORAGE STRUCTURES, SEDIMENT BARRIERS, FLOW CONVEYANCES, REVEGETATION, DISCHARGE CONTROL, STRUCTURES, AND OTHER STORMWATER MANAGEMENT STRUCTURES SHOULD BE BUILT AND CONTINUOUSLY MAINTAINED DURING PROJECT CONSTRUCTION IN A MANNER SUCH THAT, TO THE EXTENT POSSIBLE, THE STRUCTURES ARE INCORPORATED INTO AND BECOME PART OF THE PERMANENT SURFACE WATER MANAGEMENT SYSTEM.
2. THE OWNER/PERMITTEE SHALL ENSURE THAT THE SURFACE WATER AND STORMWATER MANAGEMENT MEASURES PROPOSED IN THE PLAN ARE EFFECTIVELY IMPLEMENTED UNTIL COMPLETION OF THE PROJECT OR UNTIL THE PERMANENT SURFACE WATER MANAGEMENT SYSTEM IS OPERATIONAL.
3. THE SITE SHALL REMAIN FREE OF EXCESS DUST AND DEBRIS AT ALL TIMES. ANY INCIDENCE OF EROSION, SEDIMENTATION, DUST OR DEBRIS OCCURRING OFF-SITE AS A RESULT OF CONSTRUCTION ACTIVITIES ON THIS DEVELOPMENT SHALL BE CORRECTED BY THE CONTRACTOR IMMEDIATELY (FOR EACH OCCURRENCE).
4. ALL STORM WATER MANAGEMENT SYSTEMS SHALL BE COMPLETED PRIOR TO CONSTRUCTION OF IMPERVIOUS AREAS.
5. SILT FENCE, STRAW BALE INLET FILTERS, AND ANY OTHER EROSION/SEDIMENTATION PROTECTION SHOWN ON THESE PLANS SHALL BE INSTALLED IMMEDIATELY FOLLOWING SITE CLEARING AND PRIOR TO ANY SITE DEVELOPMENT. ALL EROSION/SEDIMENTATION PROTECTION SHALL BE MAINTAINED DURING THE LIFE OF THE CONSTRUCTION PROJECT AND REMOVED AFTER COMPLETION.
6. CONSTRUCTION WASTE - WASTE SHALL BE COLLECTED AT A DESIGNATED AREA ON-SITE. ADEQUATE NUMBER OF CONTAINERS SHALL BE PROVIDED (WHEN POSSIBLE COVER CONTAINERS OR PROVIDE LIDS ON CONTAINERS). ARRANGE FOR WASTE COLLECTION BEFORE CONTAINERS OVERFLOW, PROVIDE CLEAN UP IMMEDIATELY IF SPILLAGE OCCURS.
7. CONTROL AND DISPOSAL OF WASTES - CONTRACTOR SHALL DEVELOP AND IMPLEMENT A PLAN TO ASSURE THAT ALL WASTE, SUCH AS DISCARDED BUILDING MATERIALS, CONCRETE TRUCK WASH-OUT, CHEMICALS, LITTER AND SANITARY WASTE, ARE PROPERLY CONTROLLED WHILE ON-SITE AND TRANSPORTED AND DISPOSED OF (OFF-SITE) IN ACCORDANCE WITH ALL APPLICABLE LOCAL, STATE, AND FEDERAL REGULATIONS. NO WASTE MATERIALS OF ANY KIND ARE PERMITTED TO BE BURIED ON-SITE OR DISCHARGED TO SURFACE WATERS OF THE STATE OR TO THE CITY'S STORM WATER SYSTEM.
8. CONCRETE TRUCKS - EMPTING OR WASH OUT OF EXCESS CONCRETE MAY BE ALLOWED ON-SITE. EXCESS CONCRETE AND WASH WATER SHOULD BE DISPOSED OF IN A MANNER THAT PREVENTS CONTACT BETWEEN THESE MATERIALS AND STORMWATER WHICH WILL BE DISCHARGED FROM THE SITE. FOR EXAMPLE, DIKES COULD BE CONSTRUCTED AROUND THE AREA TO CONTAIN THESE MATERIALS UNTIL THEY HARDEN, AT WHICH TIME THEY MAY BE PROPERLY DISPOSED OF.
9. CONTRACTOR SHALL PERIODICALLY SWEEP ALL EXISTING ON-SITE PAVED SURFACES AND OFF-SITE ABUTTING CITY STREETS AND STATE HIGHWAYS AS NEEDED TO KEEP THOSE SURFACES IN A SEDIMENT-FREE CONDITION. SWEEPING SHALL BE DONE BY MECHANICAL MEANS, WITH WATER SUPPLEMENT, ON A REGULAR BASIS SEVERAL TIMES A WEEK INCLUDING, MOST PARTICULARLY, AFTER EVERY RAIN EVENT AND EVERY FRIDAY AFTERNOON PRIOR TO CEASING WORK FOR THE WEEK.
10. SANITARY/SEPTIC DISPOSAL - DOMESTIC WASTE HAULERS SHOULD BE CONTRACTED TO REGULARLY REMOVE THE SANITARY AND SEPTIC WASTES AND TO MAINTAIN THE FACILITIES IN GOOD WORKING ORDER.
11. PETROLEUM PRODUCTS - OIL, GASOLINE, LUBRICANTS, AND ASPHALTIC SUBSTANCES SUCH AS PAVING MATERIALS SHOULD BE HANDLED CAREFULLY TO MINIMIZE THEIR EXPOSURE TO SURFACE WATERS. EQUIPMENT SHOULD BE ON SITE AND CLEANED UP PETROLEUM SPILL IN FUEL STORAGE AREAS OR ON BOARD TRANSPORTATION AND FUELING VEHICLES. CONTAIN AND CLEAN UP PETROLEUM SPILLS IMMEDIATELY.
12. HAZARDOUS PRODUCTS - THESE PRODUCTS SHALL BE USED IN A SAFE MANNER TO AVOID POLLUTION OF STORM WATER. EQUIPMENT SHOULD BE ON-SITE TO CONTAIN AND CLEAN UP SPILLS OF HAZARDOUS MATERIALS IN THE AREAS WHERE THESE MATERIALS ARE STORED OR USED. CONTAIN AND CLEAN UP SPILLS IMMEDIATELY AFTER THEY OCCUR.
13. NON-STORM WATER DISCHARGES - THESE DISCHARGES INCLUDE BUT NOT LIMITED TO: FIRE HYDRANT FLUSHINGS, POTABLE WATER SOURCES (FLUSHINGS) IRRIGATION, BUILDING WASHDOWN, AND AIR CONDITIONING CONDENSATION. PRIOR TO ANY DISCHARGE, ALL DOWNSLOPE SITE SEDIMENTATION AND EROSION CONTROLS SHOULD BE IN PLACE. DISCHARGE SHOULD ONLY BE DIRECTED TO AREAS THAT ARE STABILIZED TO MINIMIZE EROSION (E.G., BUFFER ZONE, VEGETATED FILTER STRIPES, INLET AND OUTLET PROTECTION, LEVEL SPREADERS, ETC.) DO NOT DISCHARGE NON-STORM WATER FLOWS ONTO DISTURBED AREAS.
14. A STORMWATER POLLUTION PREVENTION PLAN INSPECTION REPORT IS REQUIRED AT LEAST ONCE A WEEK AND WITHIN 24 HOURS OF THE END OF A STORM EVENT THAT IS 0.5 INCHES OR GREATER. THE REPORTS ARE TO BE FILED AT THE PROJECT SITE WITH THE STORM WATER POLLUTION PREVENTION PLAN.

I CERTIFY UNDER PENALTY OF LAW THAT I UNDERSTAND, AND SHALL COMPLY WITH, THE TERMS AND CONDITIONS OF THE STATE OF FLORIDA GENERIC PERMIT FOR STORMWATER DISCHARGE FROM LARGE AND SMALL CONSTRUCTION ACTIVITIES AND THIS STORMWATER POLLUTION PREVENTION PLAN PREPARED THEREUNDER.

THE STORMWATER MANAGEMENT MEASURES PROPOSED ON THIS PLAN SHALL BE EFFECTIVELY IMPLEMENTED AND MAINTAINED UNTIL COMPLETION OF THE PROJECT OR UNTIL THE PERMANENT SURFACE WATER MANAGEMENT SYSTEM IS OPERATIONAL.

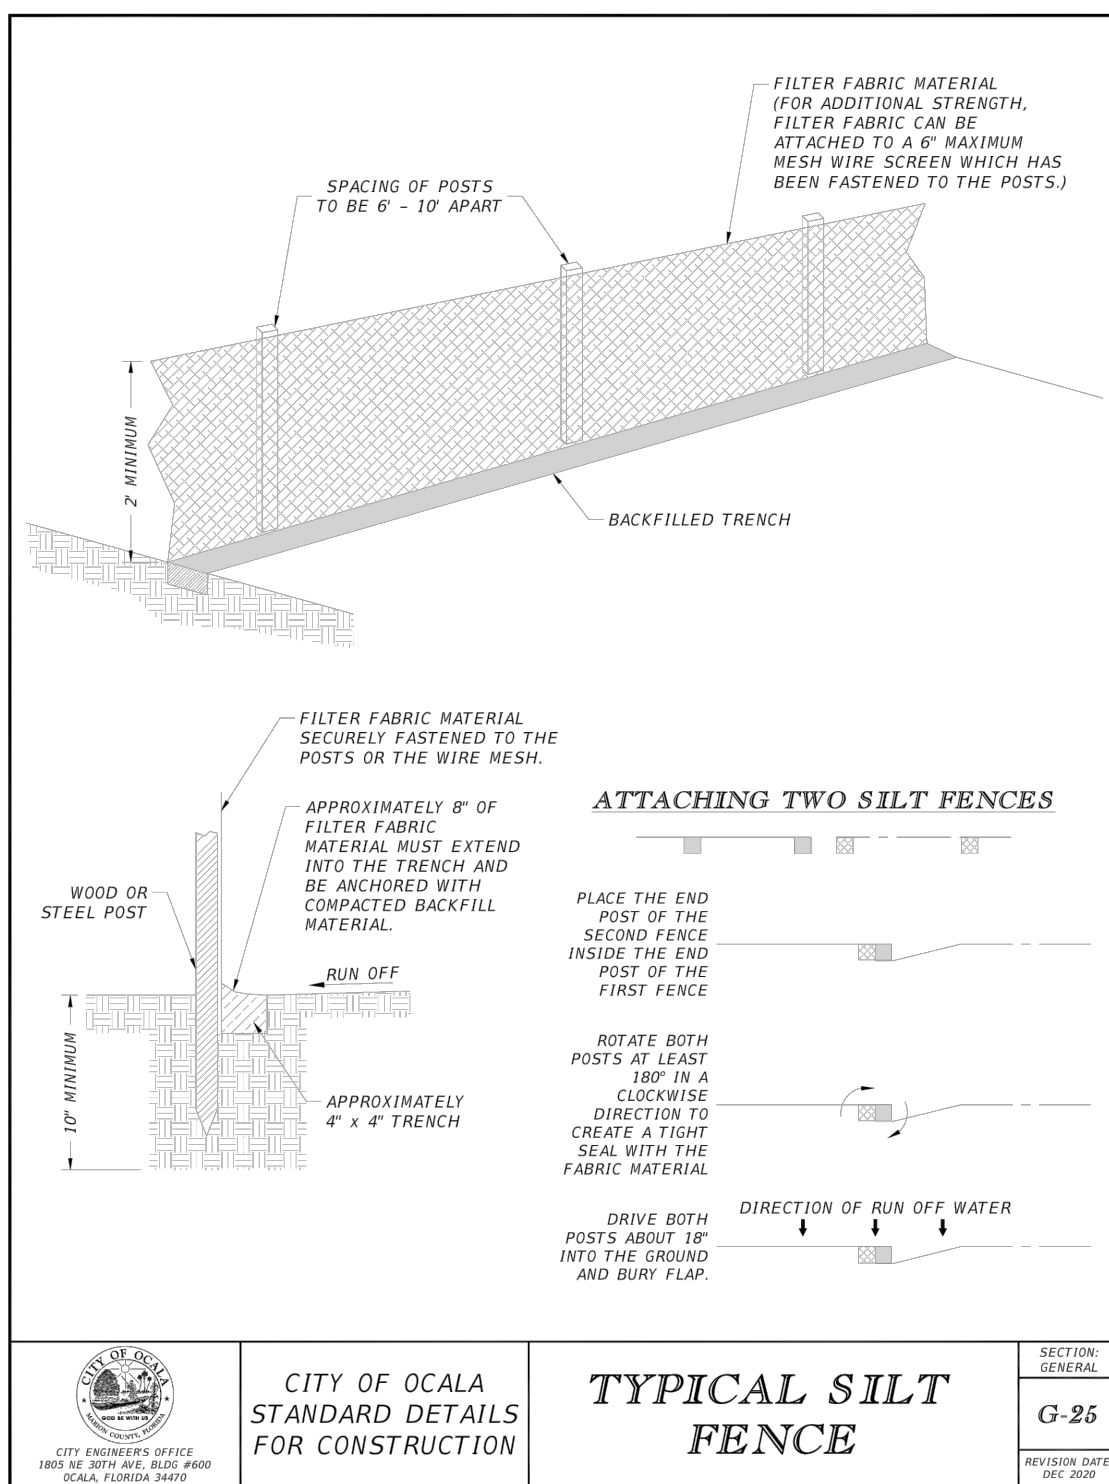

NAME _____ DATE: _____
TITLE _____

NAME _____ DATE: _____

TITLE _____






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1700 SE 17TH STREET, SUITE 200, OCALA, FLORIDA 34471
PHONE: 352-438-3000
WWW.KIMLEY-HORN.COM REGISTRY NO. 35106

KHA PROJECT 142371043	LICENSED PROFESSIONAL
DATE	MUHAMMAD N. MURAD, P.E.
APRIL 2024	
SCALE AS SHOWN	FLORIDA LICENSE NUMBER
DESIGNED BY KHA	91243
DRAWN BY TEF	
CHECKED BY MNM	DATE:

STORMWATER POLLUTION PREVENTION PLAN

SUNTRAN RESTROOMS
AND KIOSK
PREPARED FOR
CITY OF OCALA












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KHA PROJECT 142371043	LICENSED PROFESSIONAL
DATE APRIL 2024	MOHAMMED N. MURAD, P.E.
SCALE AS SHOWN	FLORIDA LICENSE NUMBER 91243
DESIGNED BY KHA	DATE: ____
DRAWN BY TEF	
CHECKED BY MNM	

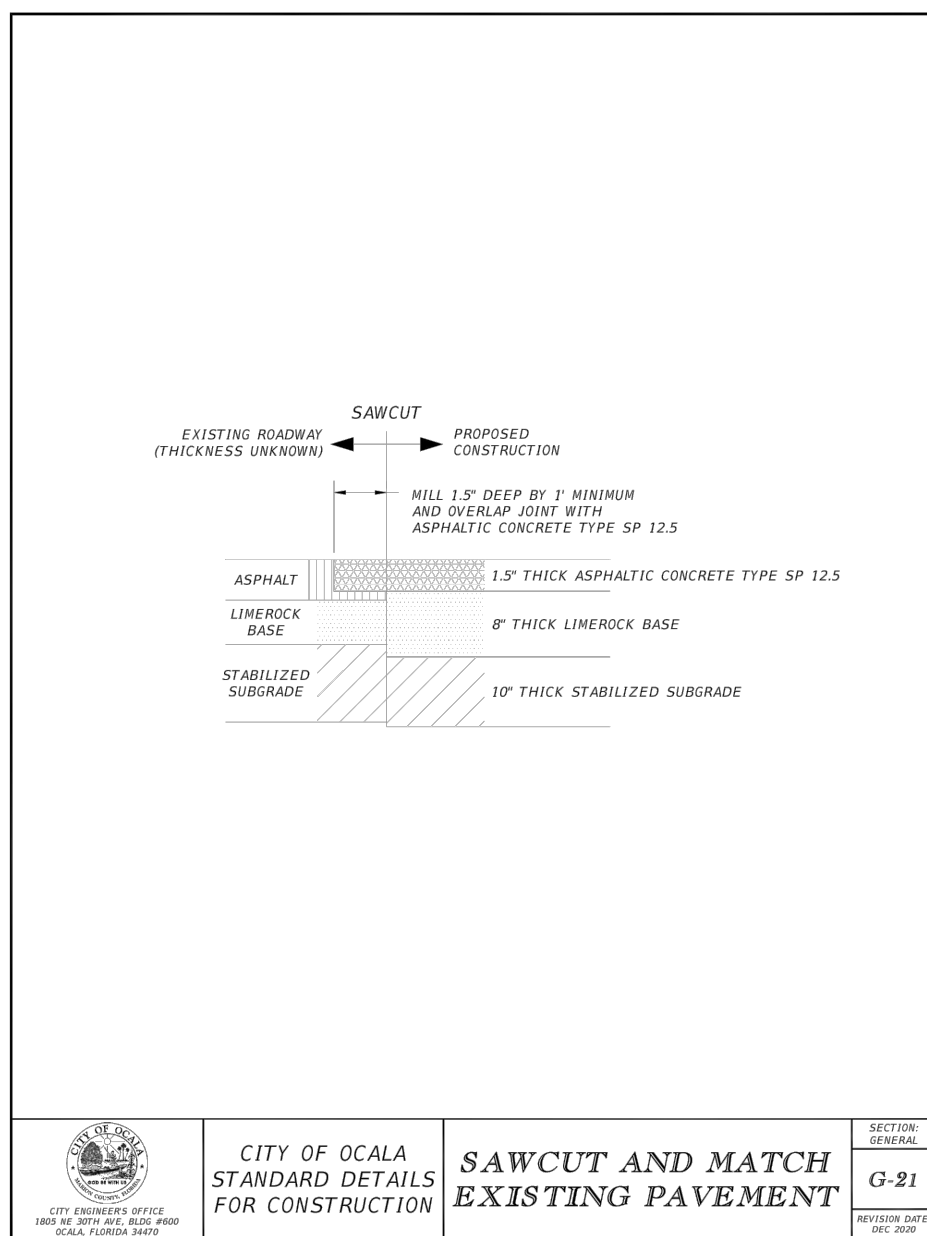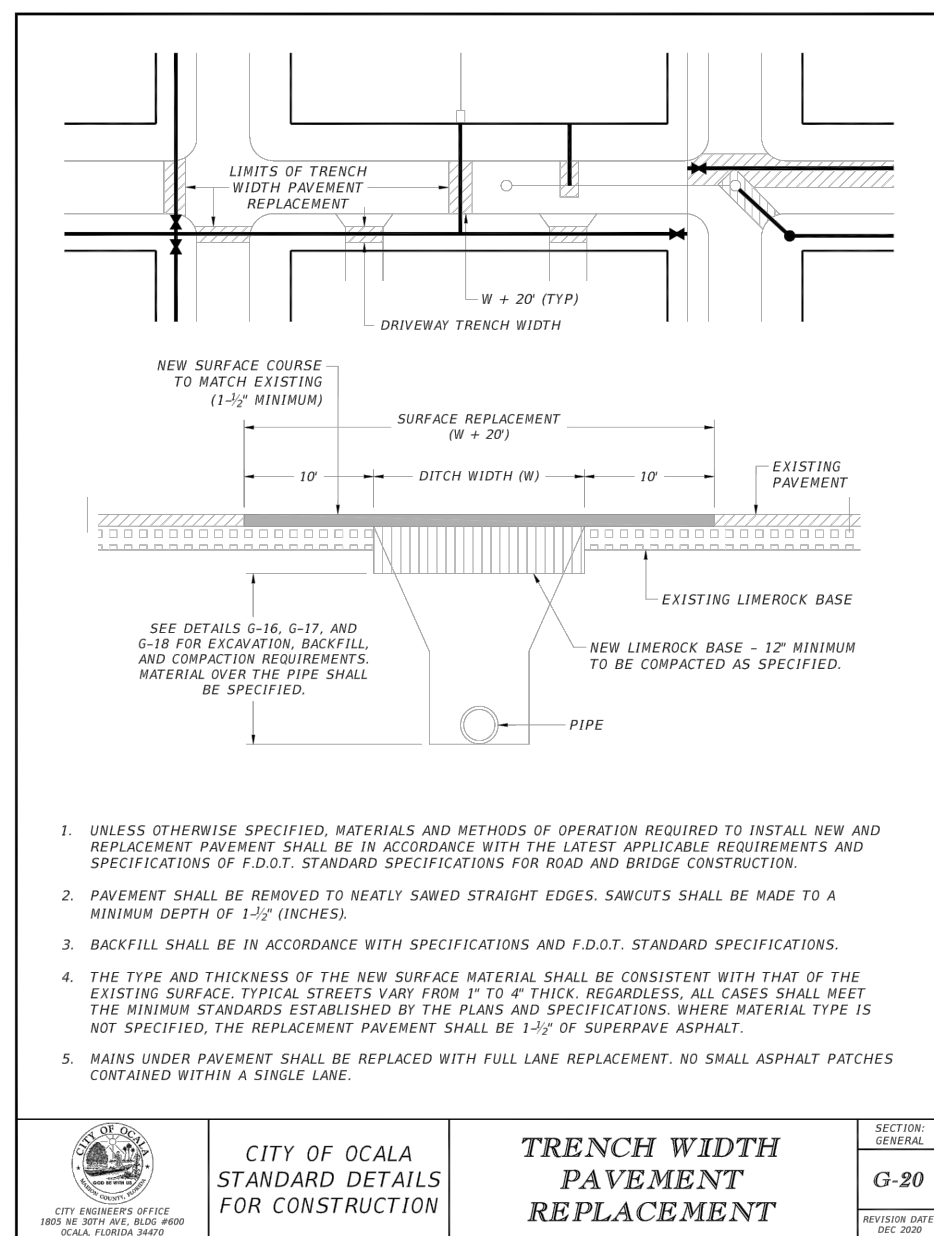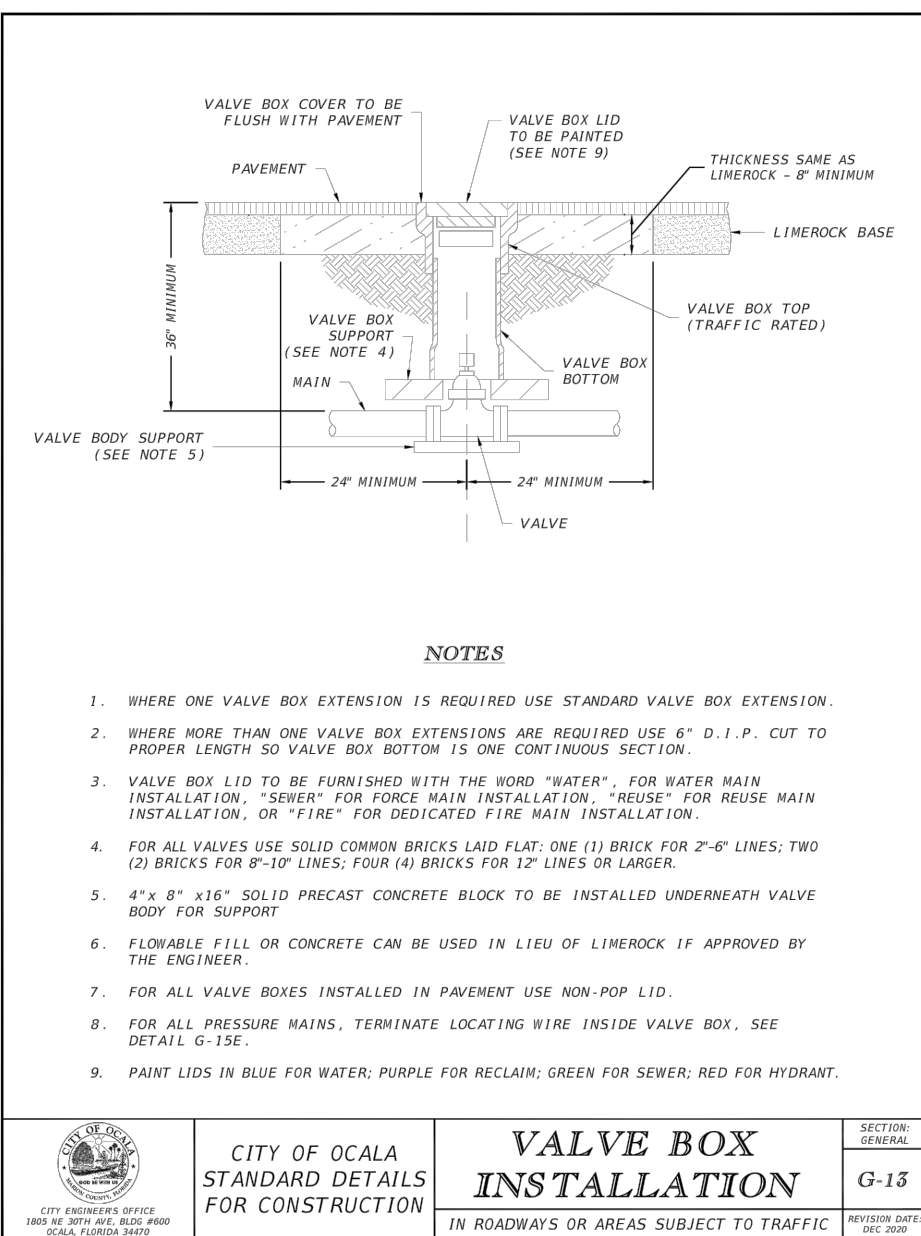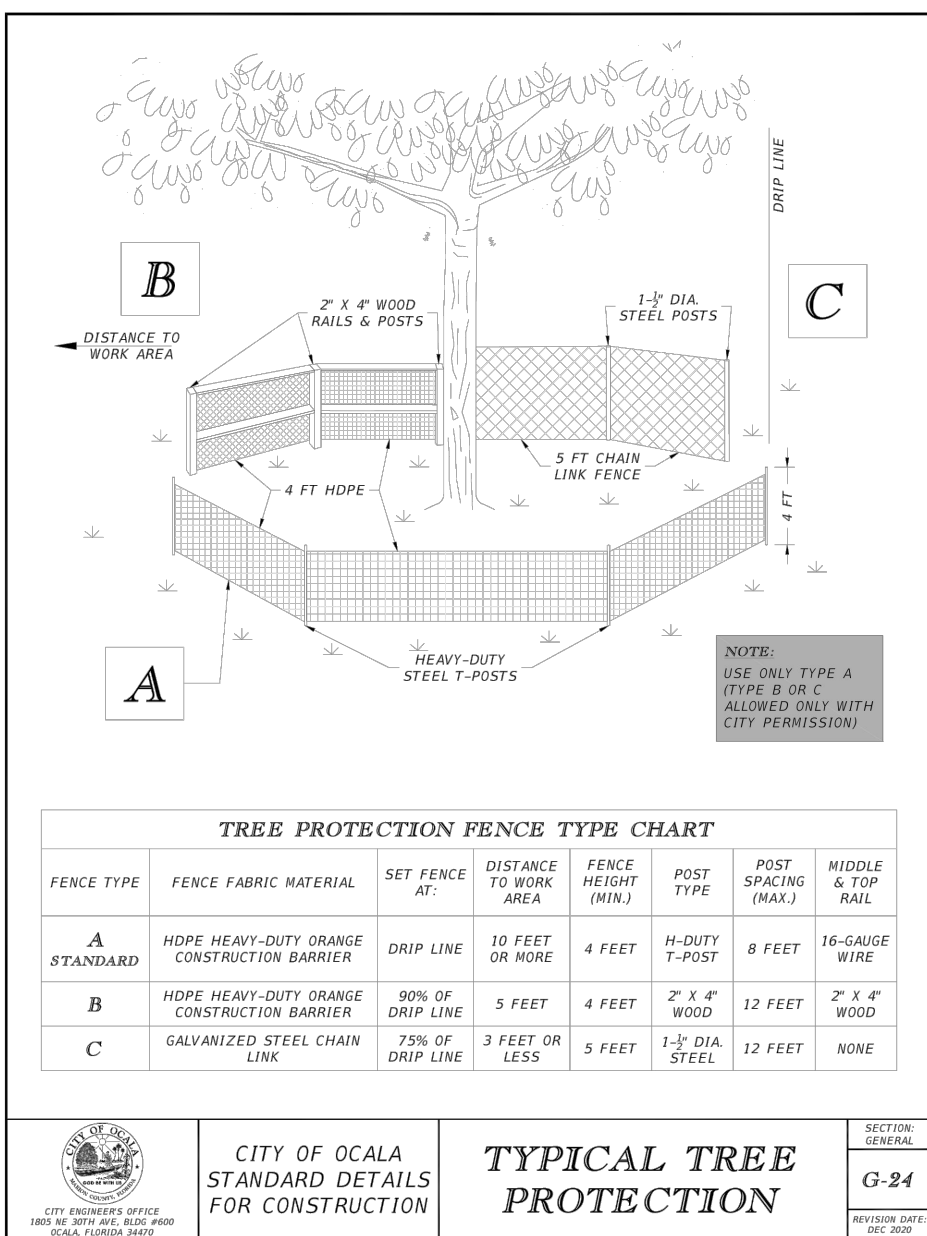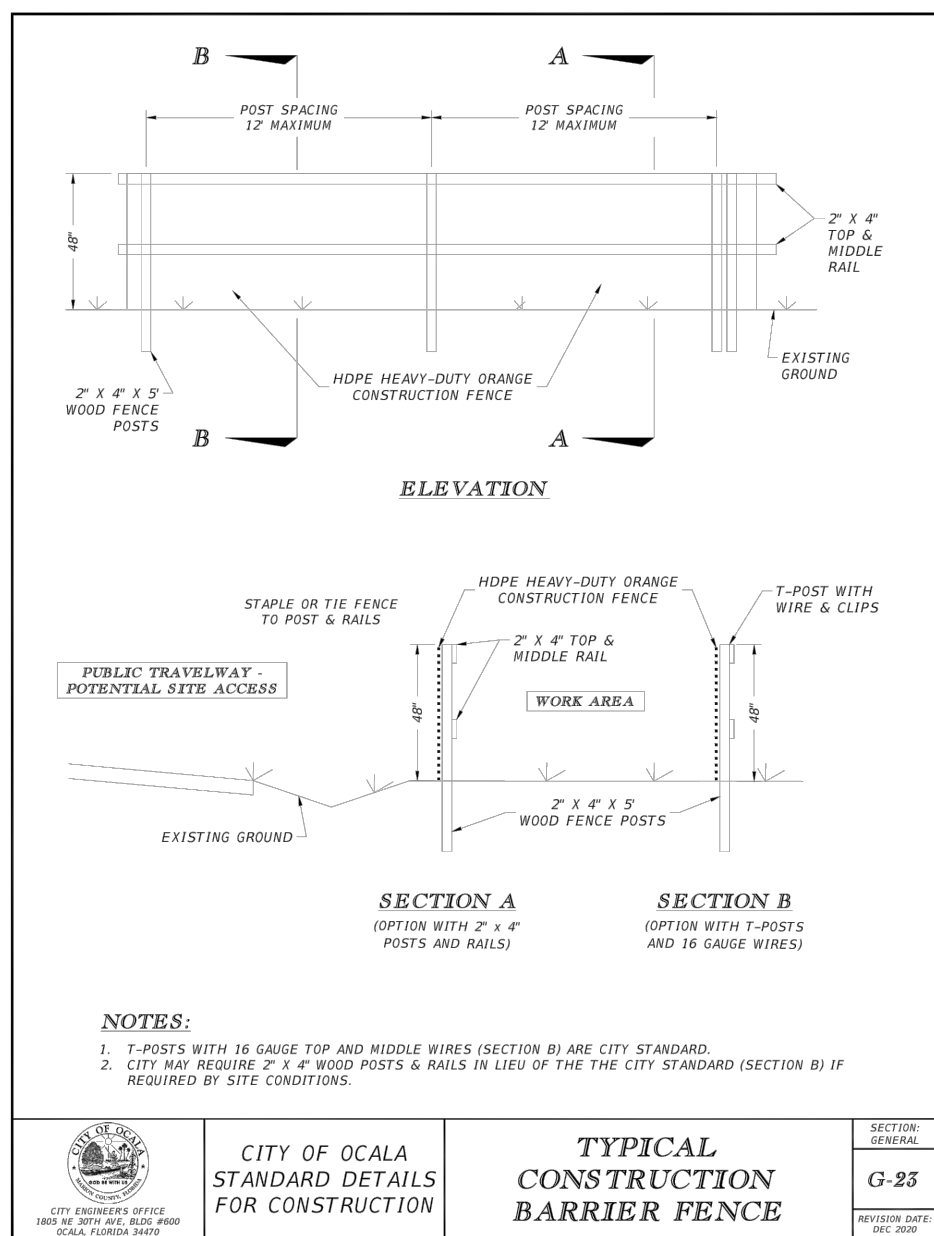



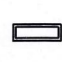






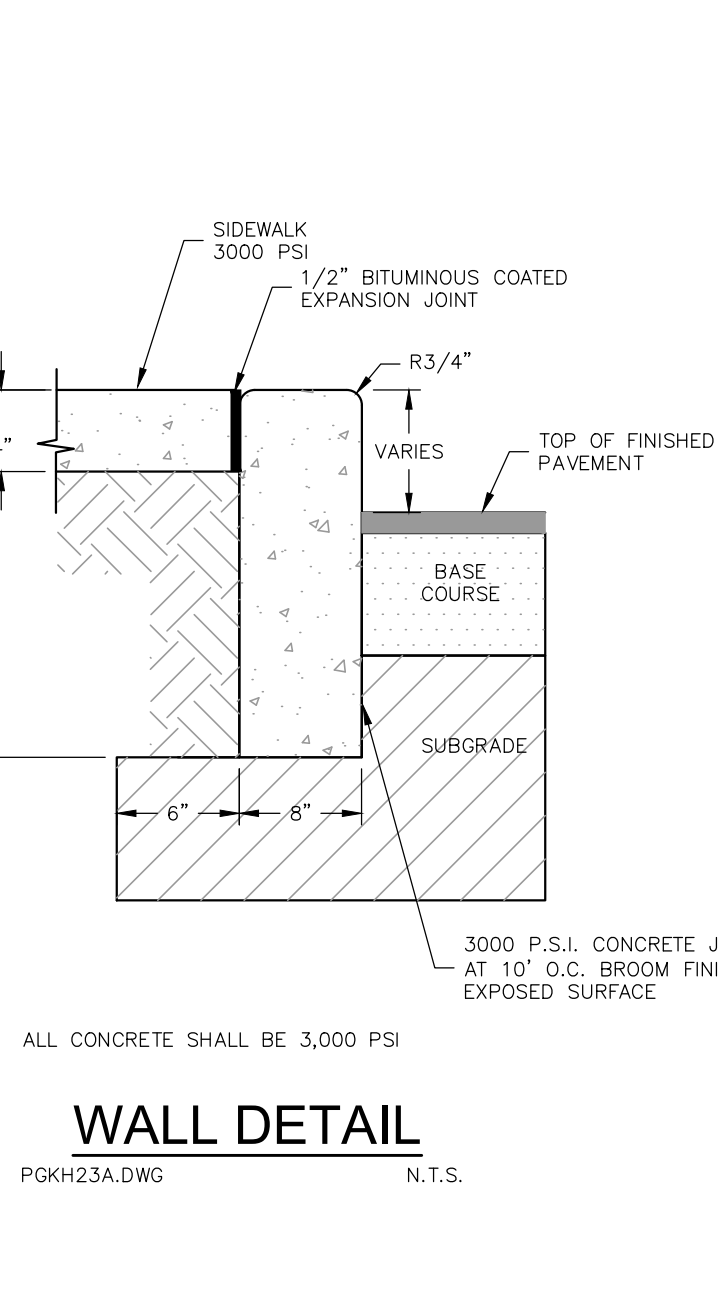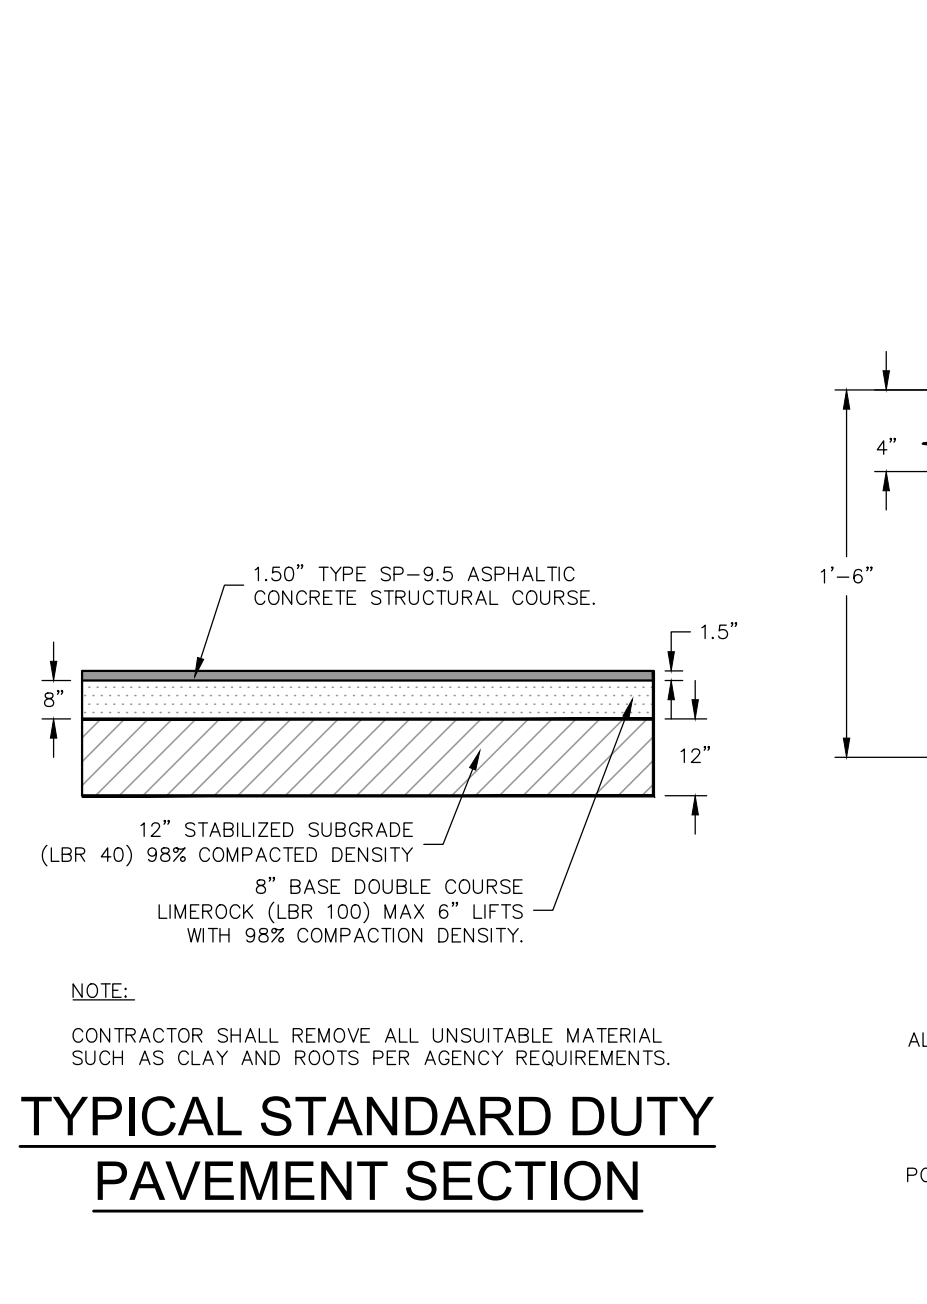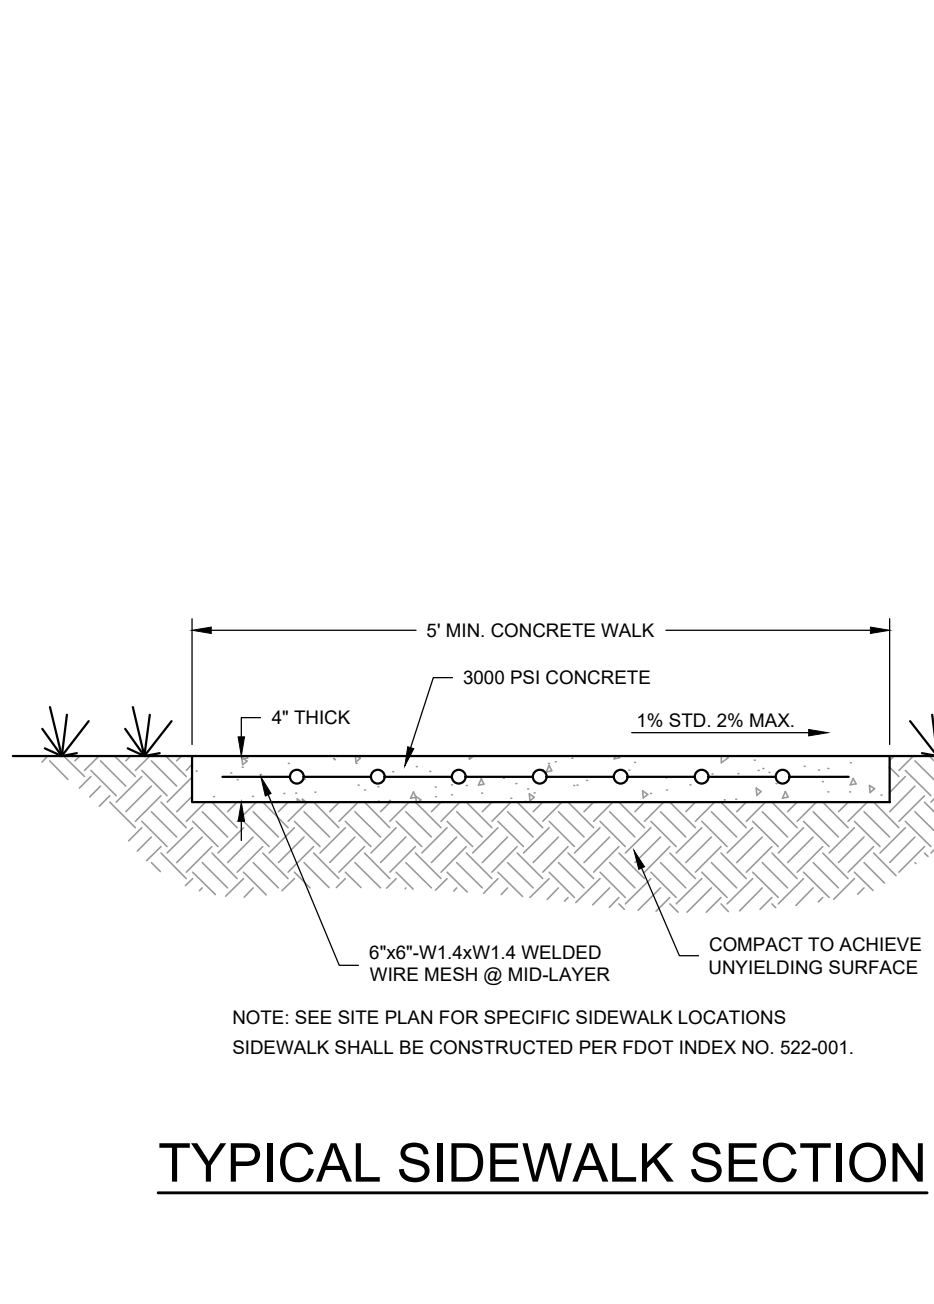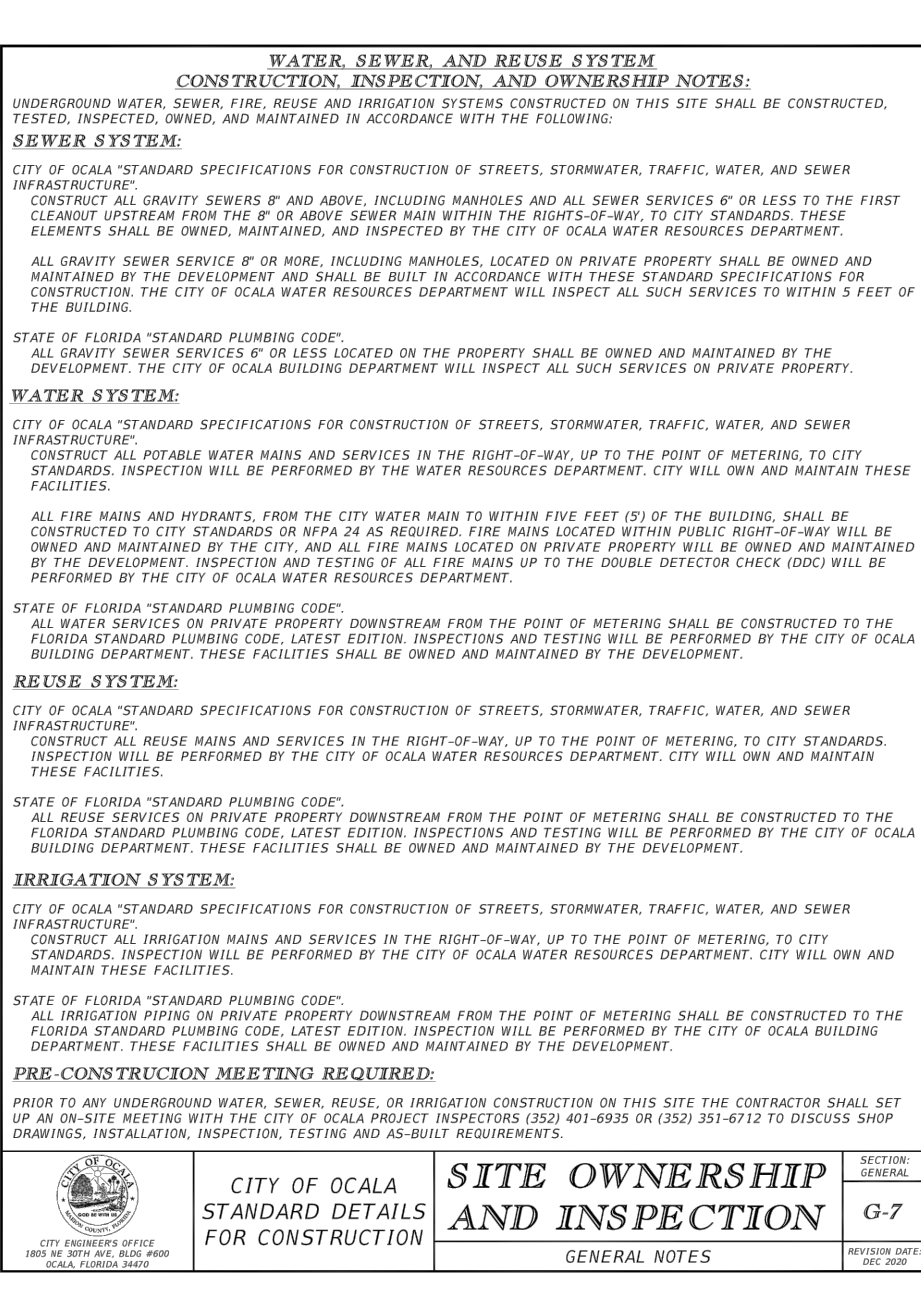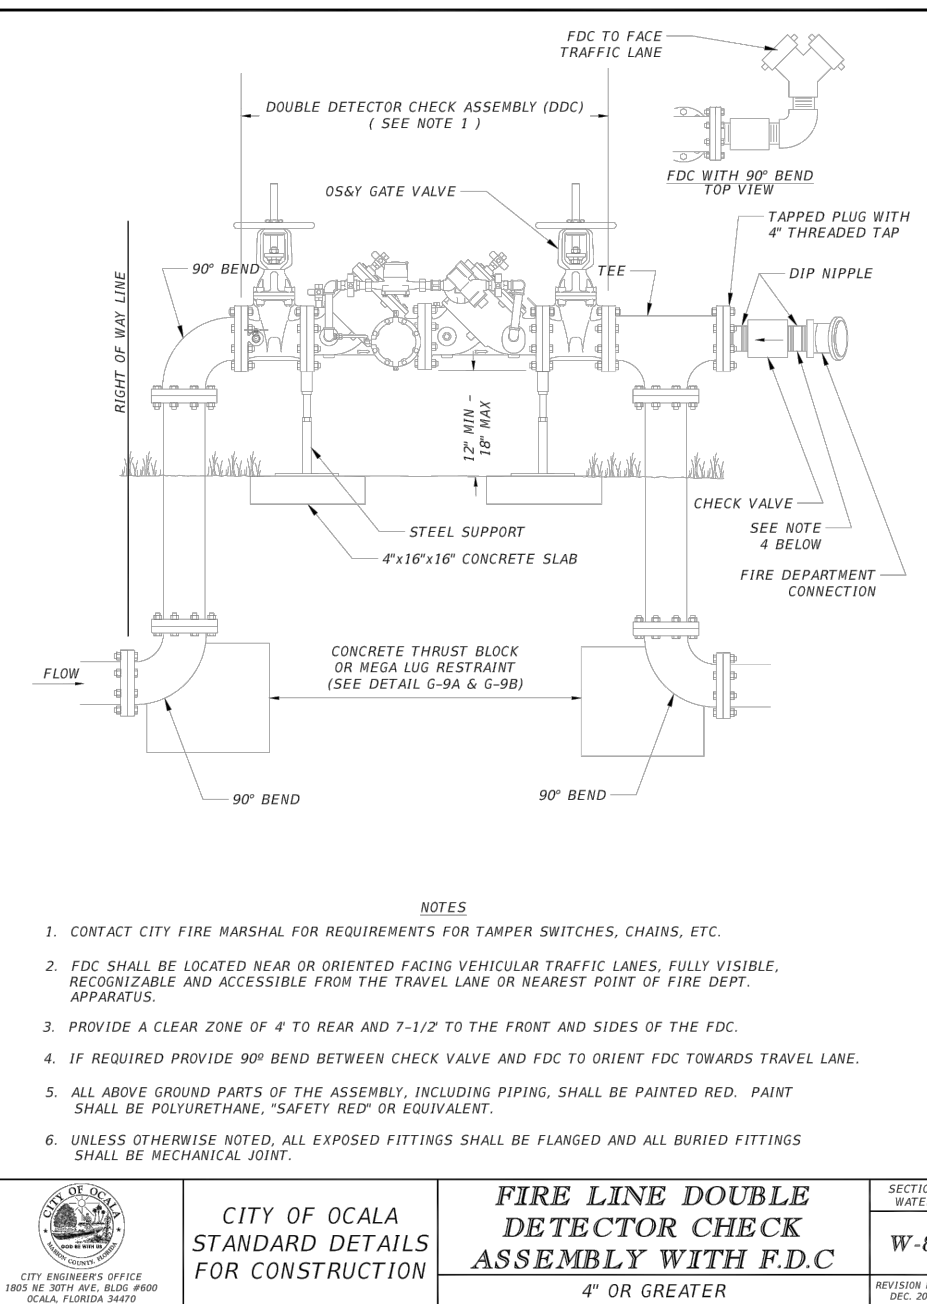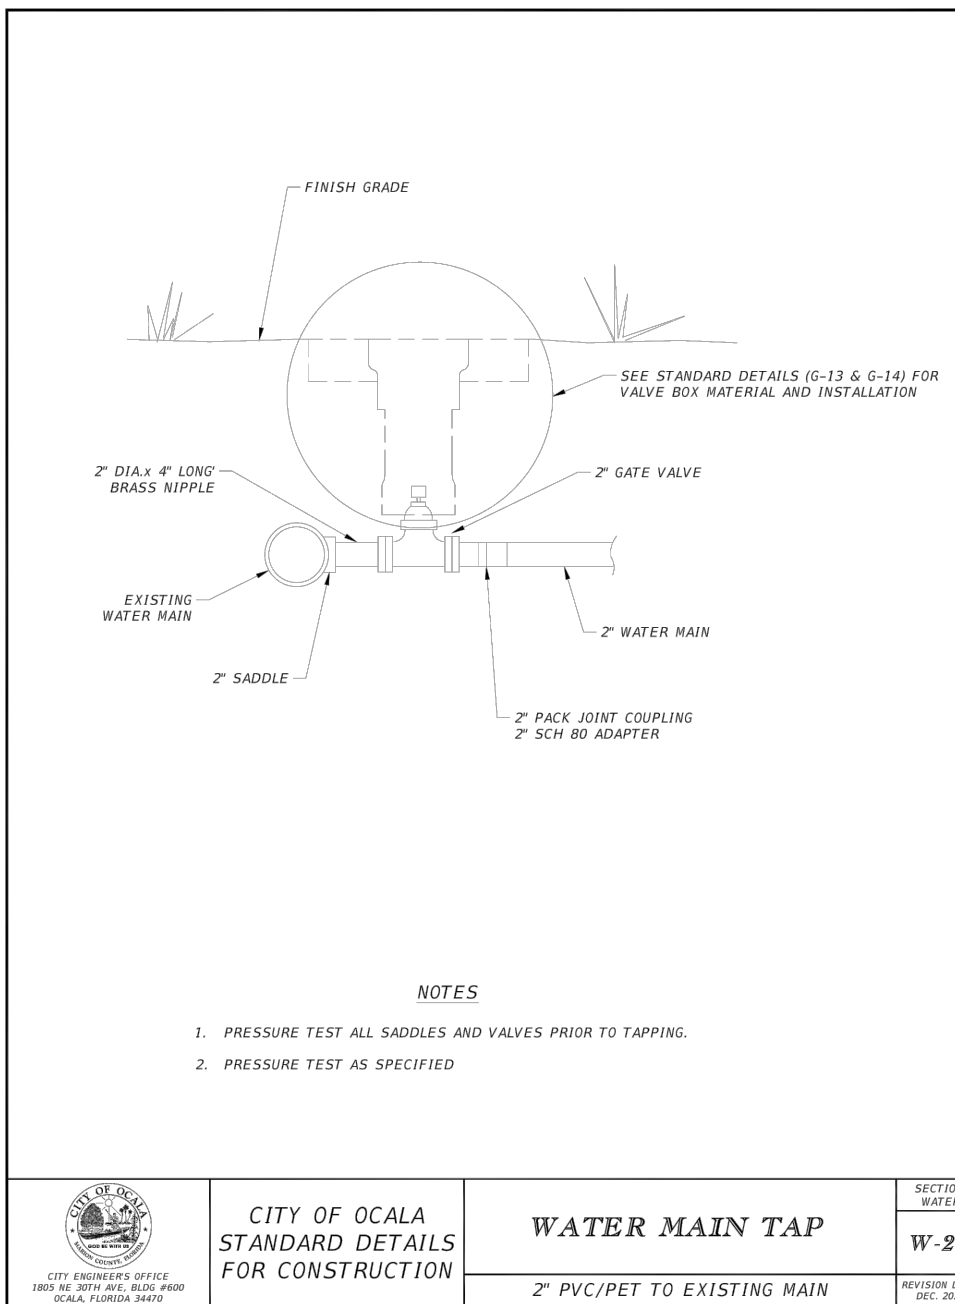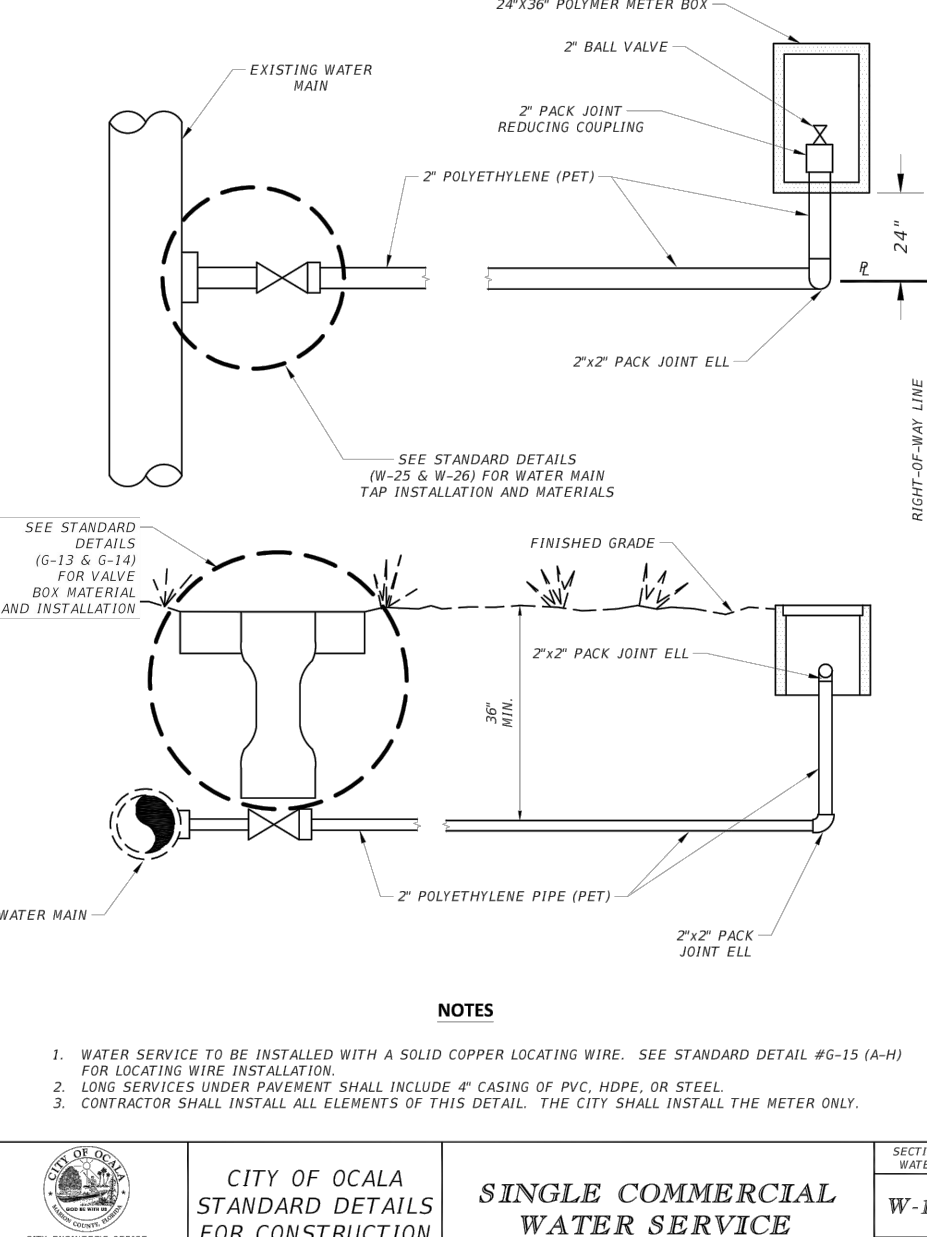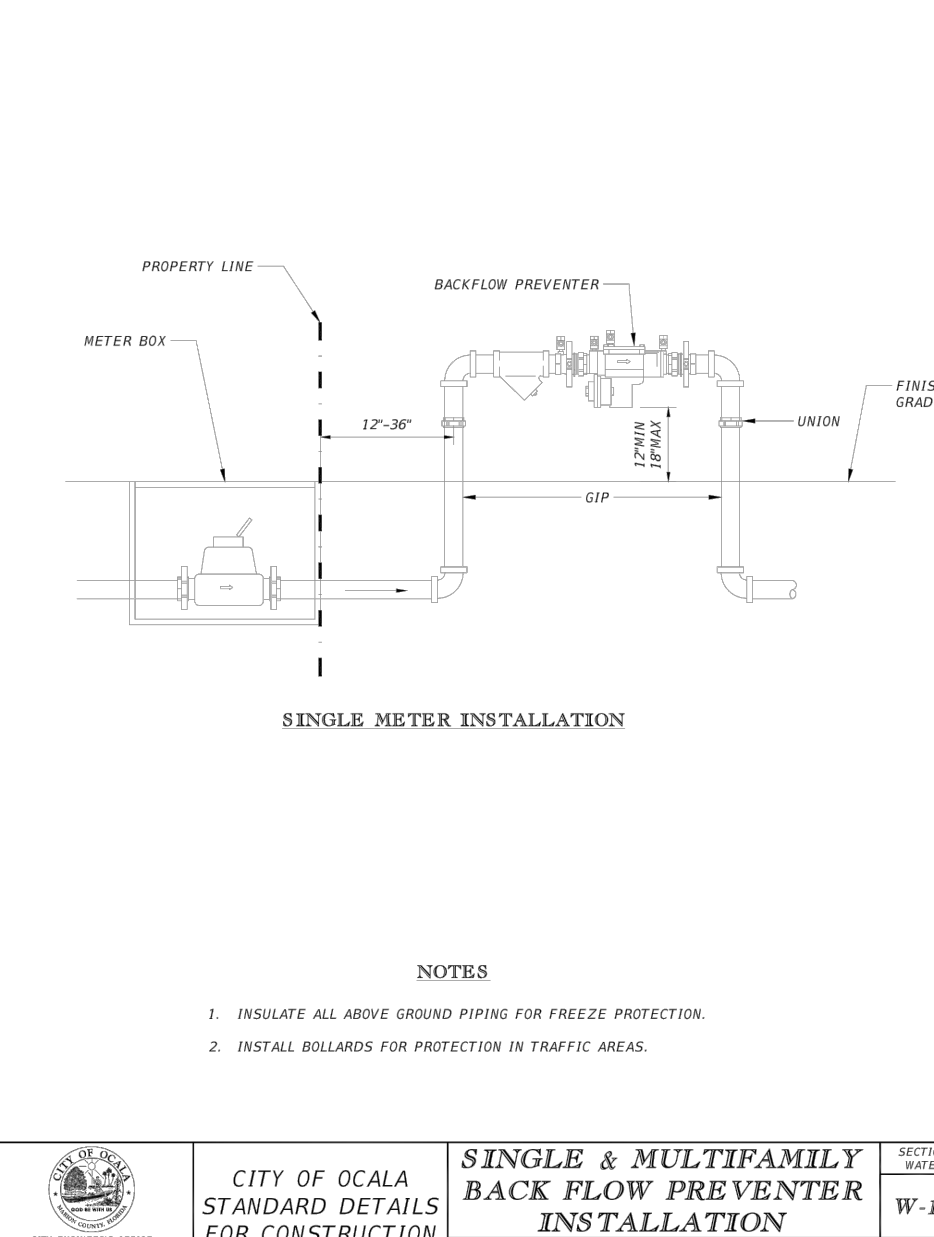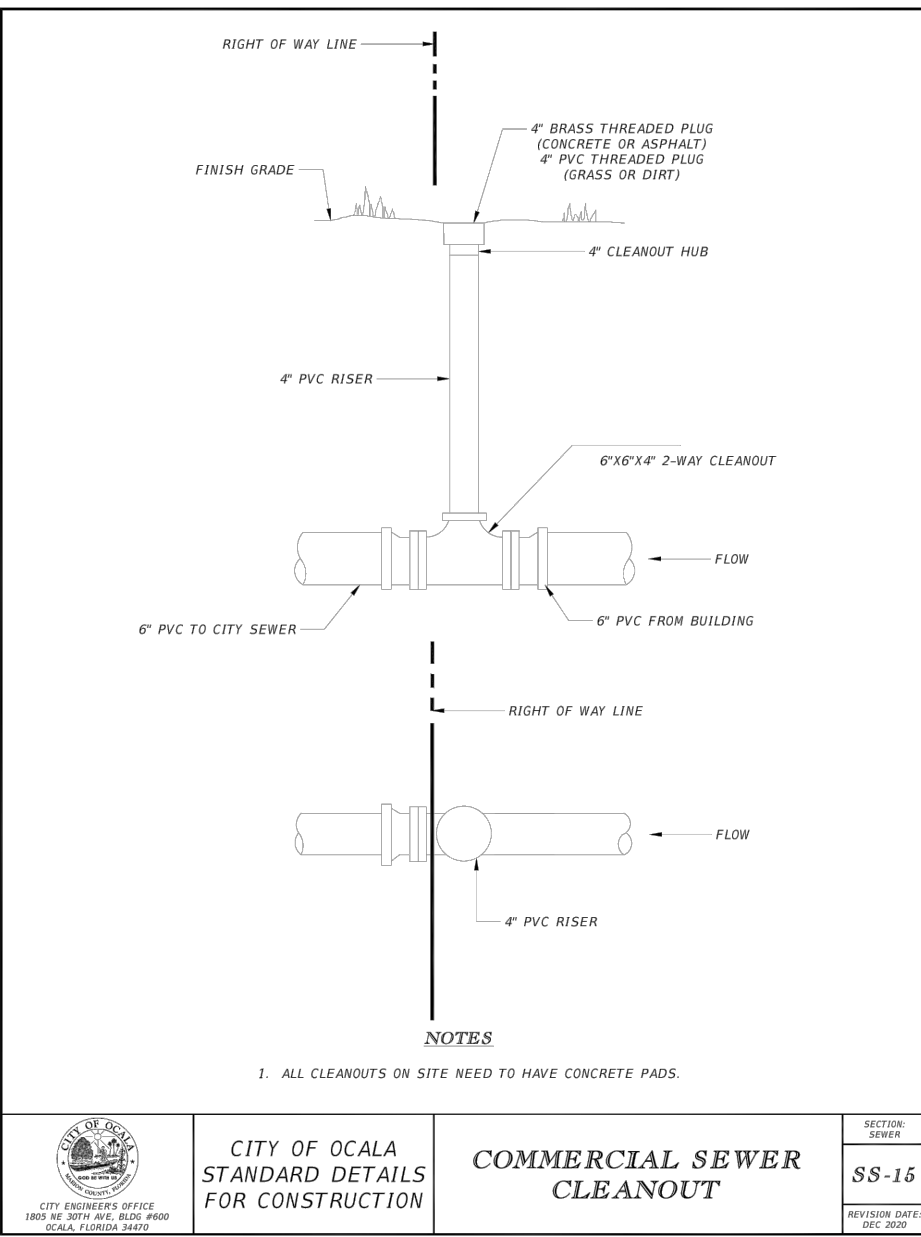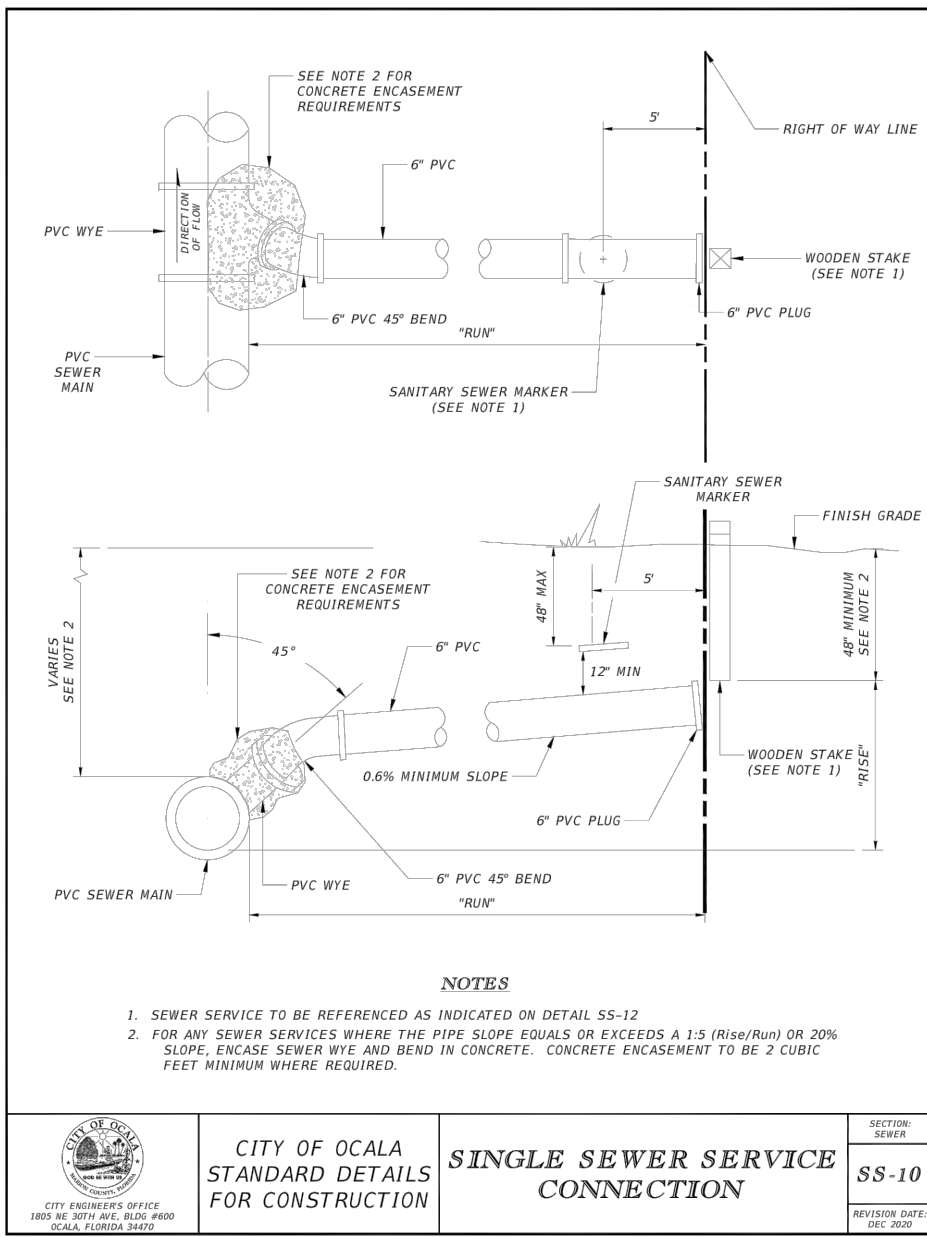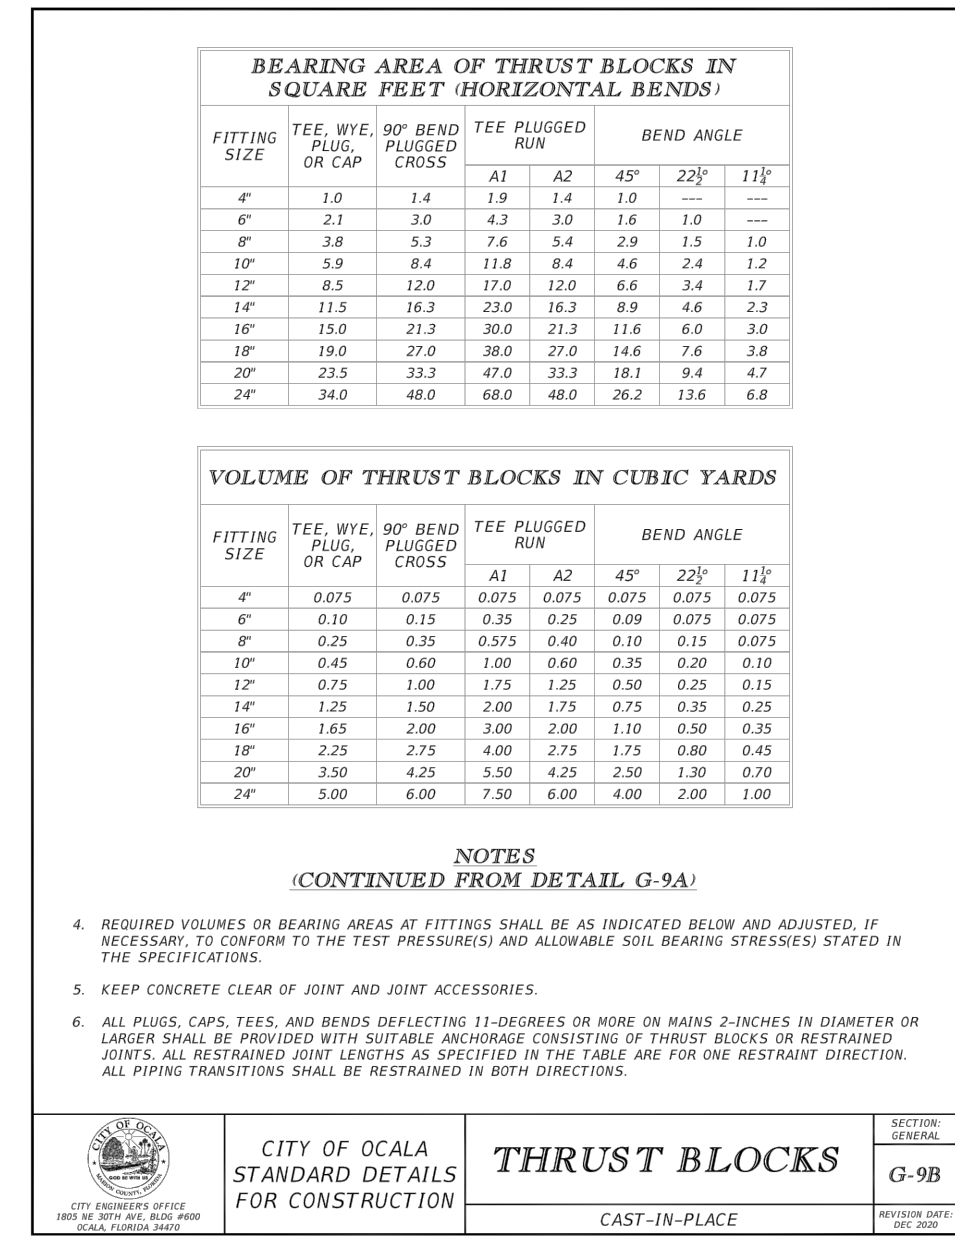








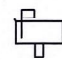




CONSTRUCTION DETAILS

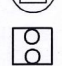SHEET NUMBER C05	SUNTRAN RESTROOMS AND KIOSK PREPARED FOR CITY OF OCALA
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FLORIDA
CITY OF OCALA

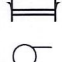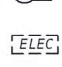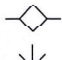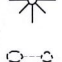



	WIRING PULL BOX		BACKFLOW PREVENTER
	MAILBOX		BOLLARD
	TELEPHONE PEDISTAL		SANITARY MANHOLE
	SINGLE POST SIGN		DRAINAGE MANHOLE
	GAS VALVE COVER	— — — — —	FENCE
	WATER VALVE COVER	— — — — —	EXIST R/W LINE
	WATER METER	— — — — —	PERMANENT EASEMENT
	SANITARY CLEANOUT	(C) =	CALCULATED
	ELECTRIC OUTLET	CB =	CHORD BEARING
	TELEPHONE PEDISTAL	CH =	CHORD LENGTH
	POST	CO. =	COMPANY
	BENCH	CONC. =	CONCRETE
	FLOOD LIGHT	COR. =	CORNER
	ELECTRIC OUTLET	(D) =	DEED
	UTILITY POLE	ELEC. =	ELECTRIC
	SPRINKLER HEAD	ENG. =	ENGINEERING
	LIGHT POLE	E/P =	EDGE OF PAVEMENT
	RAILROAD CROSSING ARM	EXIST. =	EXISTING
	MONITORING WELL	(F) =	FIELD
	GAS METER	FPKD =	FOUND PARKER-KALON NAIL & DISK
	FIRE HYDRANT	L =	ARC LENGTH
		(O/A) =	OVERALL
		O.R. =	OFFICIAL RECORDS BOOK
		P.C. =	PAGE
		PED-X =	PEDESTRIAN CROSSING
		POB =	POINT OF BEGINNING
		POC =	POINT OF COMMENCEMENT
		R =	RADIUS
		R/W =	RIGHT OF WAY
		SEC. =	SECTION
		SMND =	SET MAG NAIL & DISK
		Δ =	CURVE DELTA ANGLE

THIS SURVEY NOT VALID UNLESS IMPRINTED
WITH AN EMBOSSED SURVEYOR'S SEAL